BEDI APARTMENT PROJECT

142 ST. BOTOLPH STREET, APARTMENT 3 BOSTON, MA

ARCHITECT: TUCK+TUCK ARCHITECTS

> 29 OLD SUGAR ROAD BOLTON, MA 01740

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LIST OF DRAWINGS:

ARCHITECTURAL DRAWINGS

TL1.1 TITLE SHEET

EX1.1 EXISTING FLOOR PLANS

EX2.1 EXISTING EXTERIOR ELEVATIONS & PHOTOGRAPHS

EX3.1 EXISTING BUILDING SECTION

PROPOSED FLOOR PLANS & ROOF PLAN

PROPOSED EXTERIOR ELEVATIONS

PROPOSED BUILDING SECTION

DRAWINGS FOR: APPROVAL DATE: MAY 15, 2021

LIST OF ABBREVIATIONS:

ACOUSTICAL CEILING TILE **ADJACENT**

ABOVE FINISHED FLOOR **BENCH MARK BOTTOM OF** C. TO C. CENTER TO CENTER

CENTERLINE CEILING

CONCRETE MASONRY UNIT COLUMN

CONCRETE CUBIC DIAMETER DF **DOUGLAS FIR**

EQ **EQUAL EXTERIOR EXISTING** FINISHED FLOOR

F.O. FACE OF F.O.C. FACE OF CONCRETE F.O.M. FACE OF MASONRY F.O.S. FACE OF STUD **FINISHED**

FLR FLOOR GENERAL CONTRACTOR

GYPSUM WALL BOARD **HOT WATER INNER DIAMETER**

LONG LEG VERTICAL LONG LEG HORIZONTAL LAMINATED MASONRY OPENING

METAL NOT IN CONTRACT NOT TO SCALE

ON CENTER OUTER DIAMETER O.F.C. OUTSIDE FACE OF CONCRETE

O.F.M. OUTSIDE FACE OF MASONRY O.F.S. OUTSIDE FACE OF STUD OPPH OPPOSITE HAND PLATE

PERPENDICULAR PRESSURE TREATED PAINTED (SEE SPEC FOR PRIMER)

REFRIGERATOR REINFORCED REVISION

STAINLESS STEEL STANDARD STD STEEL

SOUTHERN YELLOW PINE T.O. TOP OF T.O.C. TOP OF CONCRETE

W.W.F. WELDED WIRE FABRIC

T.O.M. TOP OF MASONRY TYP TYPICAL U.O.N. UNLESS OTHERWISE NOTED

V.C.T. VINYL COMPOSITE TILE V.I.F. VERIFY IN FIELD W.P. WORKING POINT W.T.W. WALL TO WALL

Table 504.4: Allowable Height & Area: Type IIIB: Non-sprinklered: 4 stories above

Table 506.2: Allowable Area: Type IIIB: Non-sprinklered: 16,000 SF

508.3.3 Exception 2: Group R-2 dwelling units... shall be separated from other occupancies contiguous to them in accordance with Section 420.

Table 601: Fire-Resistance Rating Requirements for Building Elements: Type IIIB (assumed): Structural frame, interior bearing walls, nonbearing, partition walls = 0,

Table 602 Fire Resistance Rated Requirements for Exterior Walls based on Fire

705.2 Projections: Type III Construction: Projections shall be of any approved material.

CODE REVIEW

Roof Deck Living Space Addition (new 4th floor)

142 St. Botolph Street Boston, MA 02115

Located in the St. Botolph Architectural Conservation District

Zone: BA-1 Max Height: 45 Feet FAR = 2.0

Type IIIB construction (assumed) 3 floors above grade at St. Botolph Street

(including garage) Existing First Floor: 1,150 SF gross Existing Second Floor: 1,150 SF gross

Existing Basement (accessible from passageway/alley only): 1,150 SF gross

Total gross SF: 4,600 SF gross including basement & garage

Lot size: 2,138 SF

Existing Third Floor: 1,150 SF gross

Construction Narrative:

Current Use: The property has (4) condo units in it, the basement and first floor comprise one unit, the second floor has (2) units and the third floor has (1) unit. The building does not have a sprinkler system.

We are proposing to completely renovate the third-floor unit and add new habitable space on the existing roof to turn this one-story unit into a 2-story unit. The unit will be "upside-down," meaning that the living spaces will be on the new fourth floor and the bedrooms will be on the existing third floor. There will be no bedroom spaces on the new fourth floor. The existing stair to the third floor will remain, the new stair will be built above it.

The new fourth floor will be set back from St. Botolph Street so its façade is not visible from the opposite sidewalk on St. Botolph Street as required. There will be roof deck along St. Botolph Street. The new addition will be built all the way out to the back of the building. There will be a ladder fire-escape along the back of the addition leading from the new fourth floor down to the existing third floor roof deck below. Some existing mechanical equipment will be re-located to the existing third floor roof deck.

The renovated space on the third floor and the new fourth floor will have a new, compliant fire alarm system, new and reused HVAC and new electrical components.

MASS State Building Code: IBC 2015 w/Mass State Amendments 780 CMR 9th Edition dated 10/20/2017

310.4 Residential Group R-2.

420.2: Separation walls: Walls separating dwelling units in the same building... and walls separating dwelling units form other occupancies shall be constructed as fire partitions in accordance with Section 708.

420.3 Horizontal separation: Floor assemblies separating dwelling units... from other occupancies contiguous to them in the same building shall be constructed as horizontal assemblies in accordance with Section 711.

420.6 Fire alarm systems and smoke alarms.

the grade plane

floor & roof construction = 0, exterior bearing walls = 2 hours

Separation Distance: Distance less than 5' and Group R-2 Occupancies: 1 hour fire

602.3 Type III Construction

705.2.3 Combustible Projections: Combustible projections extending to within 5' of the line used to determine the fire separation distance shall be of not less than 1-hour fire resistance rated construction.

705.5 Fire-resistance ratings: The required fire-resistance rating of exterior walls with a fire separation distance of less than 10' shall be rated for exposure to fire from both sides.

Table 705.8: Maximum area of exterior wall openings based on fire separation distance and degree of opening protection: Fire separation distance: 0' to 3': Unprotected, unsprinklered: Not permitted to have openings

706.1.1 Party Walls: Any wall located on a lot line between adjacent buildings... shall be constructed as a fire wall in accordance with 706. Party walls shall be constructed without openings and shall create separate buildings.

706.2 Structural stability: Fire walls shall be designed and constructed to allow collapse of the structure on either side without collapse of the wall under fire conditions..

Table 706.4: Fire wall fire resistance ratings: R-2: 3 hours for Type IIIB construction

706.5 Horizontal continuity: Fire walls shall be continuous from exterior wall to exterior wall and shall extend not less than 18" beyond the exterior surface of the exterior walls.

706.5.1 Exterior Walls

706.6 Vertical continuity: Exception 4.

708.3 Fire partition fire-resistance rating: 1 hour.

708.4: Continuity

713.4 Shaft enclosures fire-resistance rating: Not less than 2 hours where connecting 4 stories or more and note less than 1 hour where connecting less than 4

713.14 Elevator, dumbwaiter and other hoistways: Elevator, dumbwaiter and other hoistway enclosures shall be constructed in accordance with 713 and Chapter 30.

714 Penetrations

Table 803.11 Int. Wall & Finish Req. by Occupancy: R-2 nonsprinklered:

Rooms & Enclosed spaces: Class C

Table 1006.3.2(1) Stories with access to one exit for R-2 occupancies: First, second and third story above the grade plane, not permitted at 4th story above the grade

1017.2 Exit Access Travel Distance Limitation: Groups B & R-2: 200' (non-sprinklered)

1030.1 Emergency Escape and Rescue: Basements and sleeping rooms below the fourth story above the grade plane shall have at least one exterior emergency escape and rescue opening.

1030.2 Minimum size: Emergency escape and rescue openings shall have a minimum net clear opening of 5.7 SF.

1030.2.1 Minimum dimensions: The minimum new clear opening height dimension shall be 234". The minimum net clear width dimension shall be 20". The net clear opening dimensions shall be the result of normal operation of the opening.

1030.4 Operational constraints: Emergency escape and rescue openings shall be operational from the inside of the room without the use of keys or tools...

1300 Energy Efficiency: Refers to International Energy Efficiency Code

Life Safety Code NFPA 101 2015 Edition

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ISSUED FOR: APPROVAL *0*5.15.21 AS NOTED DRAWN BY CHECKED BY 2012 Title and Site **REVISION**

Sheet Number:








APT 3


BEDI APARTMENT
142 ST. BOTOLPH STREET, APT 3
BOSTON, MA

EXISTING FLOOR PLANS

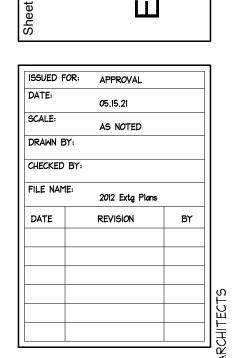

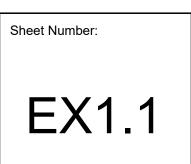

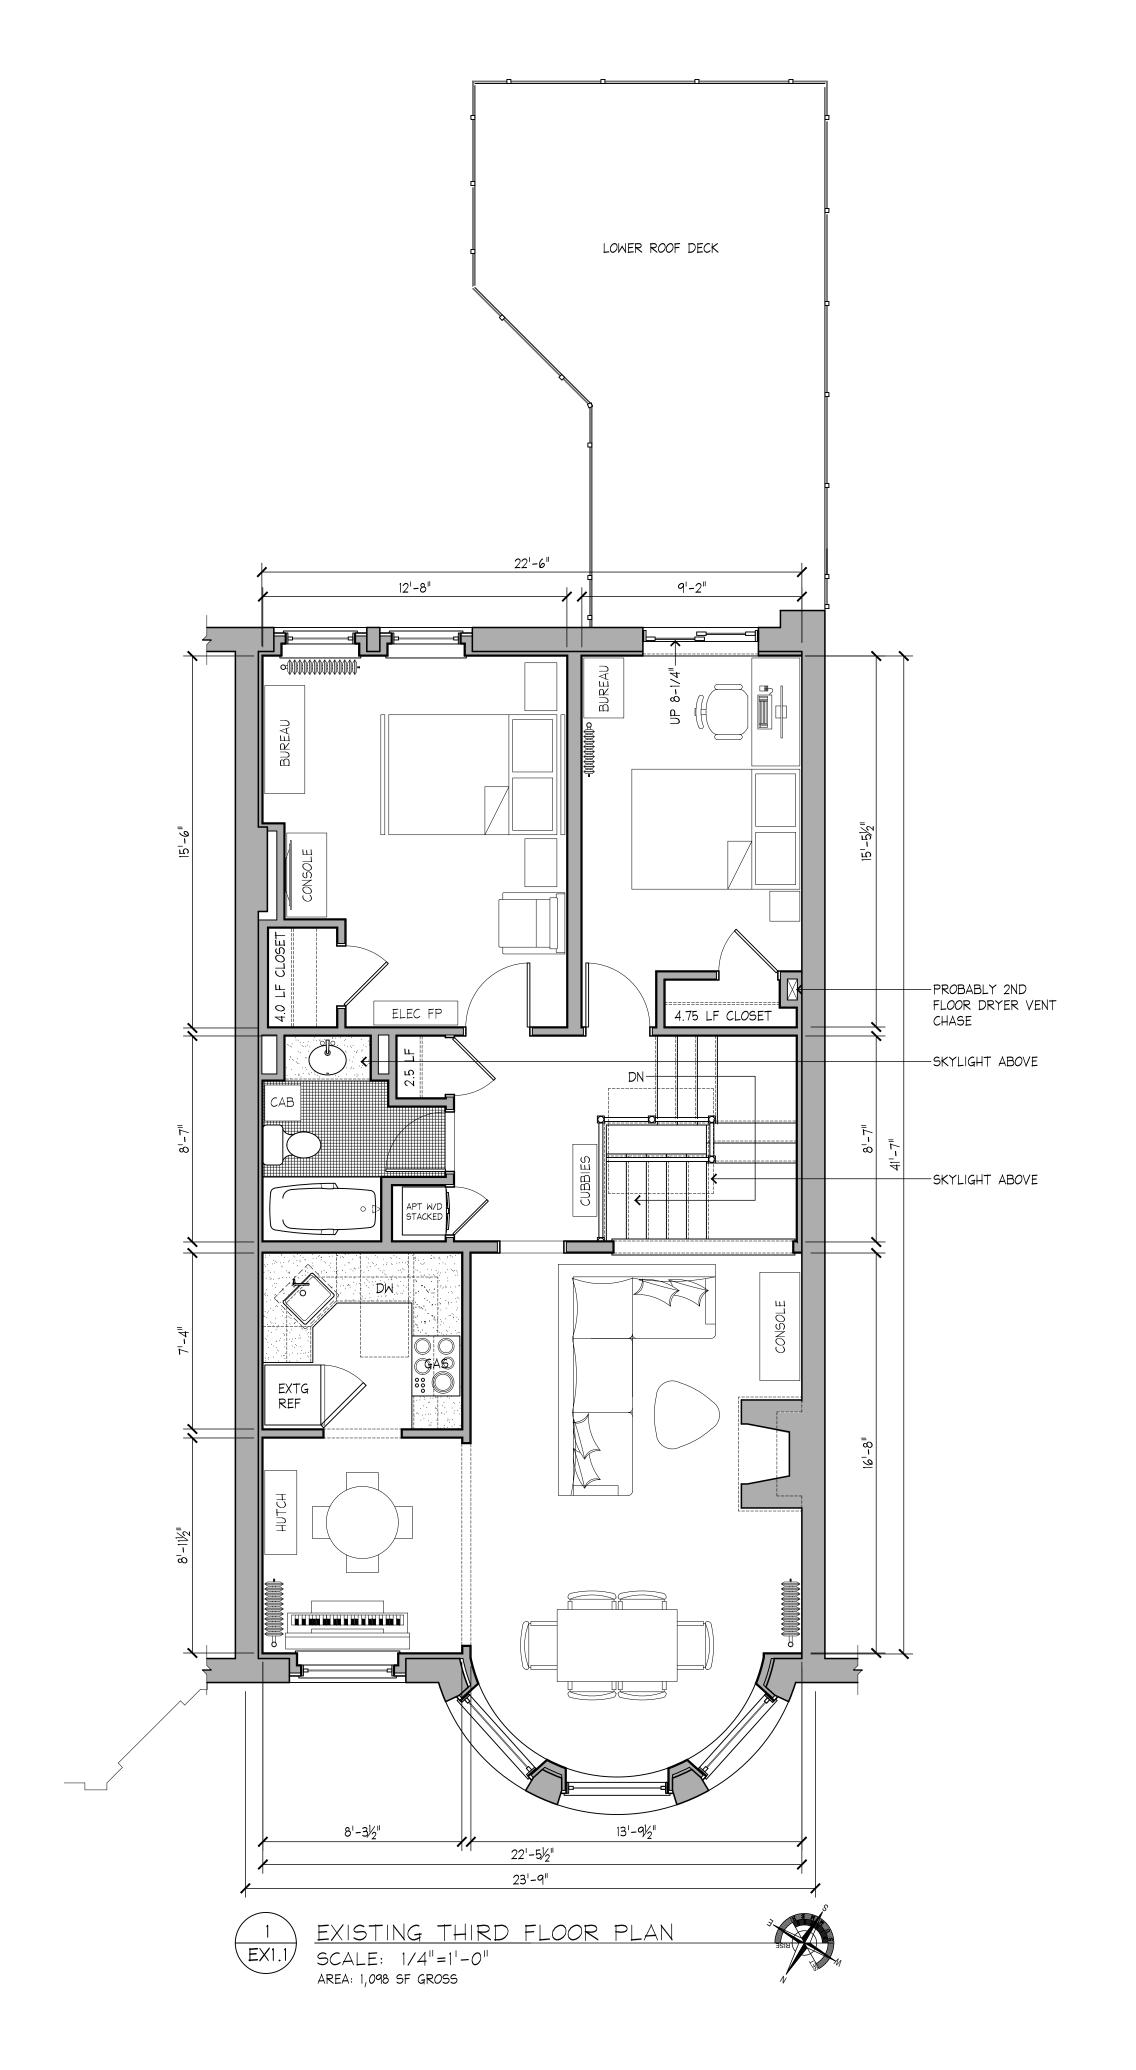

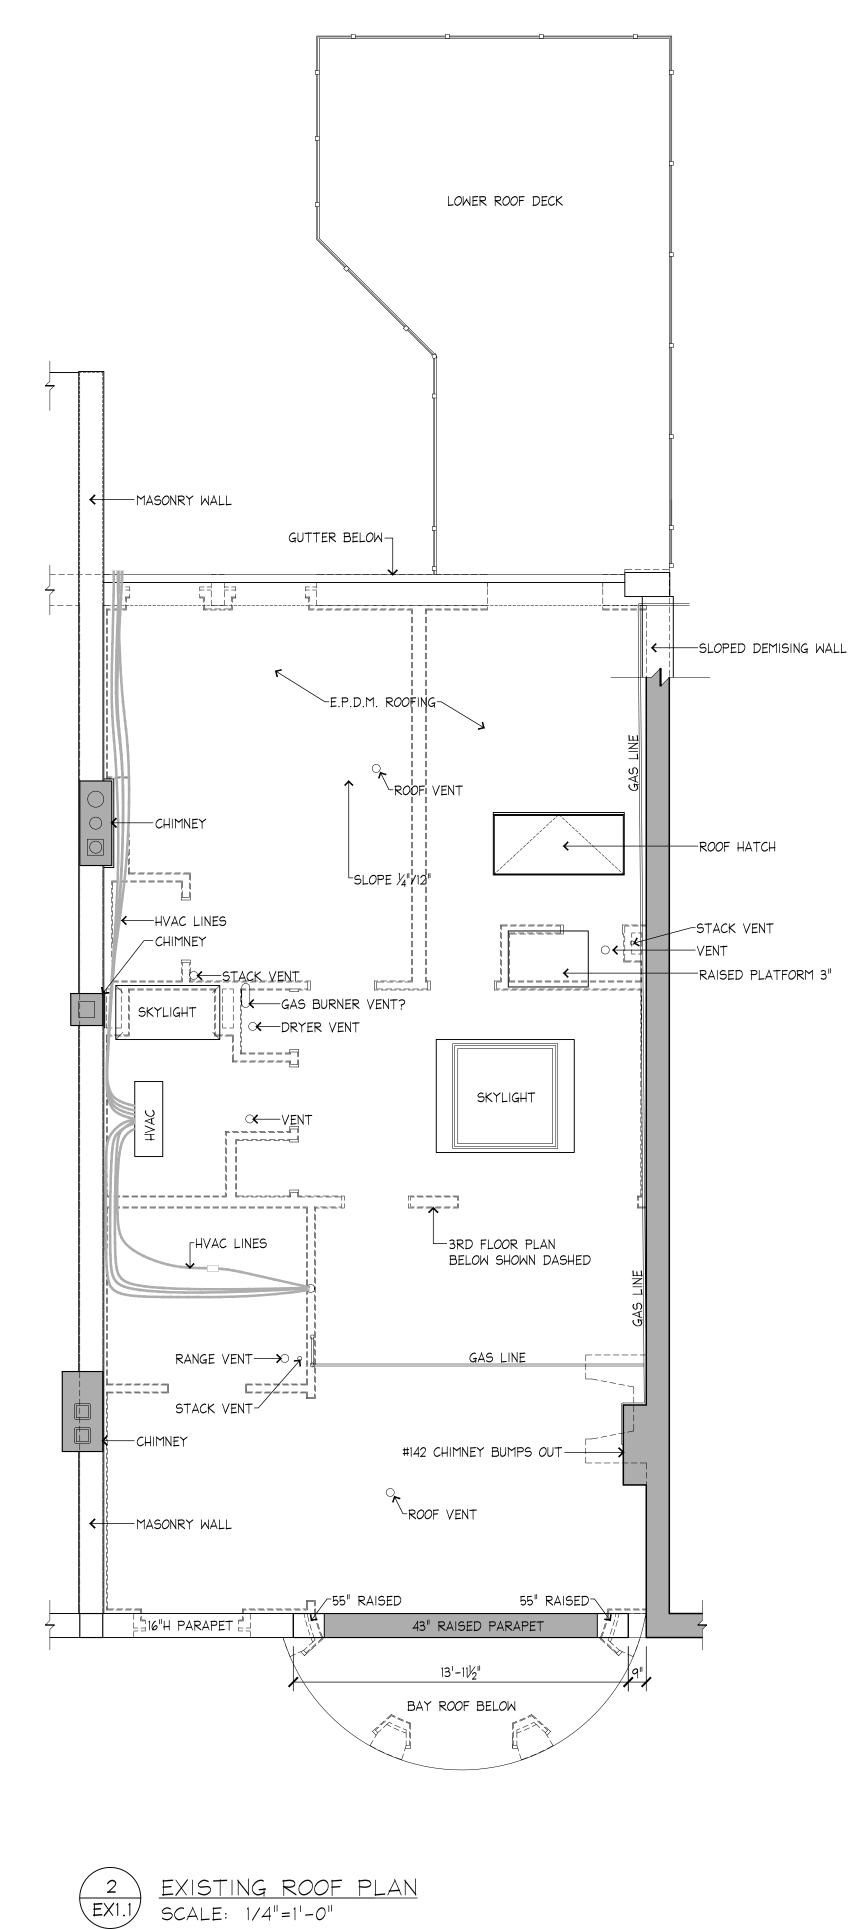

EXISTING ST BOTOLPH ST. (NORTHWEST) ELEVATION SCALE: 1/4"=1'-0"



2 ST BOTOLPH ST. (NW) ELEVATION PHOTOGRAPH SCALE: NOT TO SCALE





ST BOTOLPH ST. (SE) ELEVATION PHOTOGRAPH SCALE: NOT TO SCALE

TUCK & TUCK RCHITECTS

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EDI APARTMENT ST. BOTOLPH STREET, APT 3 STON, MA

> EXISTING EXTERIOR ELEVATIONS & PHOTOGRAPHS

| ISSUED FOR | : APPROVAL | |
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| DATE: | 05,15,21 | |
| SCALE: | AS NOTED | |
| DRAWN BY: | | |
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| FILE NAME: | 2012 Extg Eleva | itions |
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EX2.1

29 OLD SUGAR ROAD BOLTON MASSACHUSETTS 01740 p:978.779.7999 e:info@tuckandtuck.com WWW.TUCKANDTUCK.COM **APARTMENT** STREET, ← 2 BLACKWOOD STREET SIDE WALL BEYOND → HIGH PARAPET T.O. EXTG LOW PARAPET LOW PARAPET T.O. ROOF DECK LOW POINT LEXISTING CEILING LEXISTING FIN. ROOF T.O. 3RD FLR FIN. FLR T.O. 2ND FLR FIN. FLR T.O. IST FLR FIN. FLR 8'-0" SIDEWALK 42'-0" ST. BOTOLPH STREET 8'-1" SIDEWALK Sheet Number: T.O. BASEMENT SLAB 75'-4" EX3.1 SECTION THRU EXISTING BUILDING @ LOW ROOF DECK SCALE: 1/4"=1'-0"

29 OLD SUGAR ROAD BOLTON MASSACHUSETTS 01740 p: 978.7999 e:info@tuckandtuck.com W W W . T U C K A N D T U C K . C O M




STREE


PROPOSED FLOW & ROOF PLAN

ISSUED FOR: APPROVAL 05.15.21 SCALE: AS NOTED DRAWN BY: CHECKED BY FILE NAME: 2012 Plans REVISION

Sheet Number:

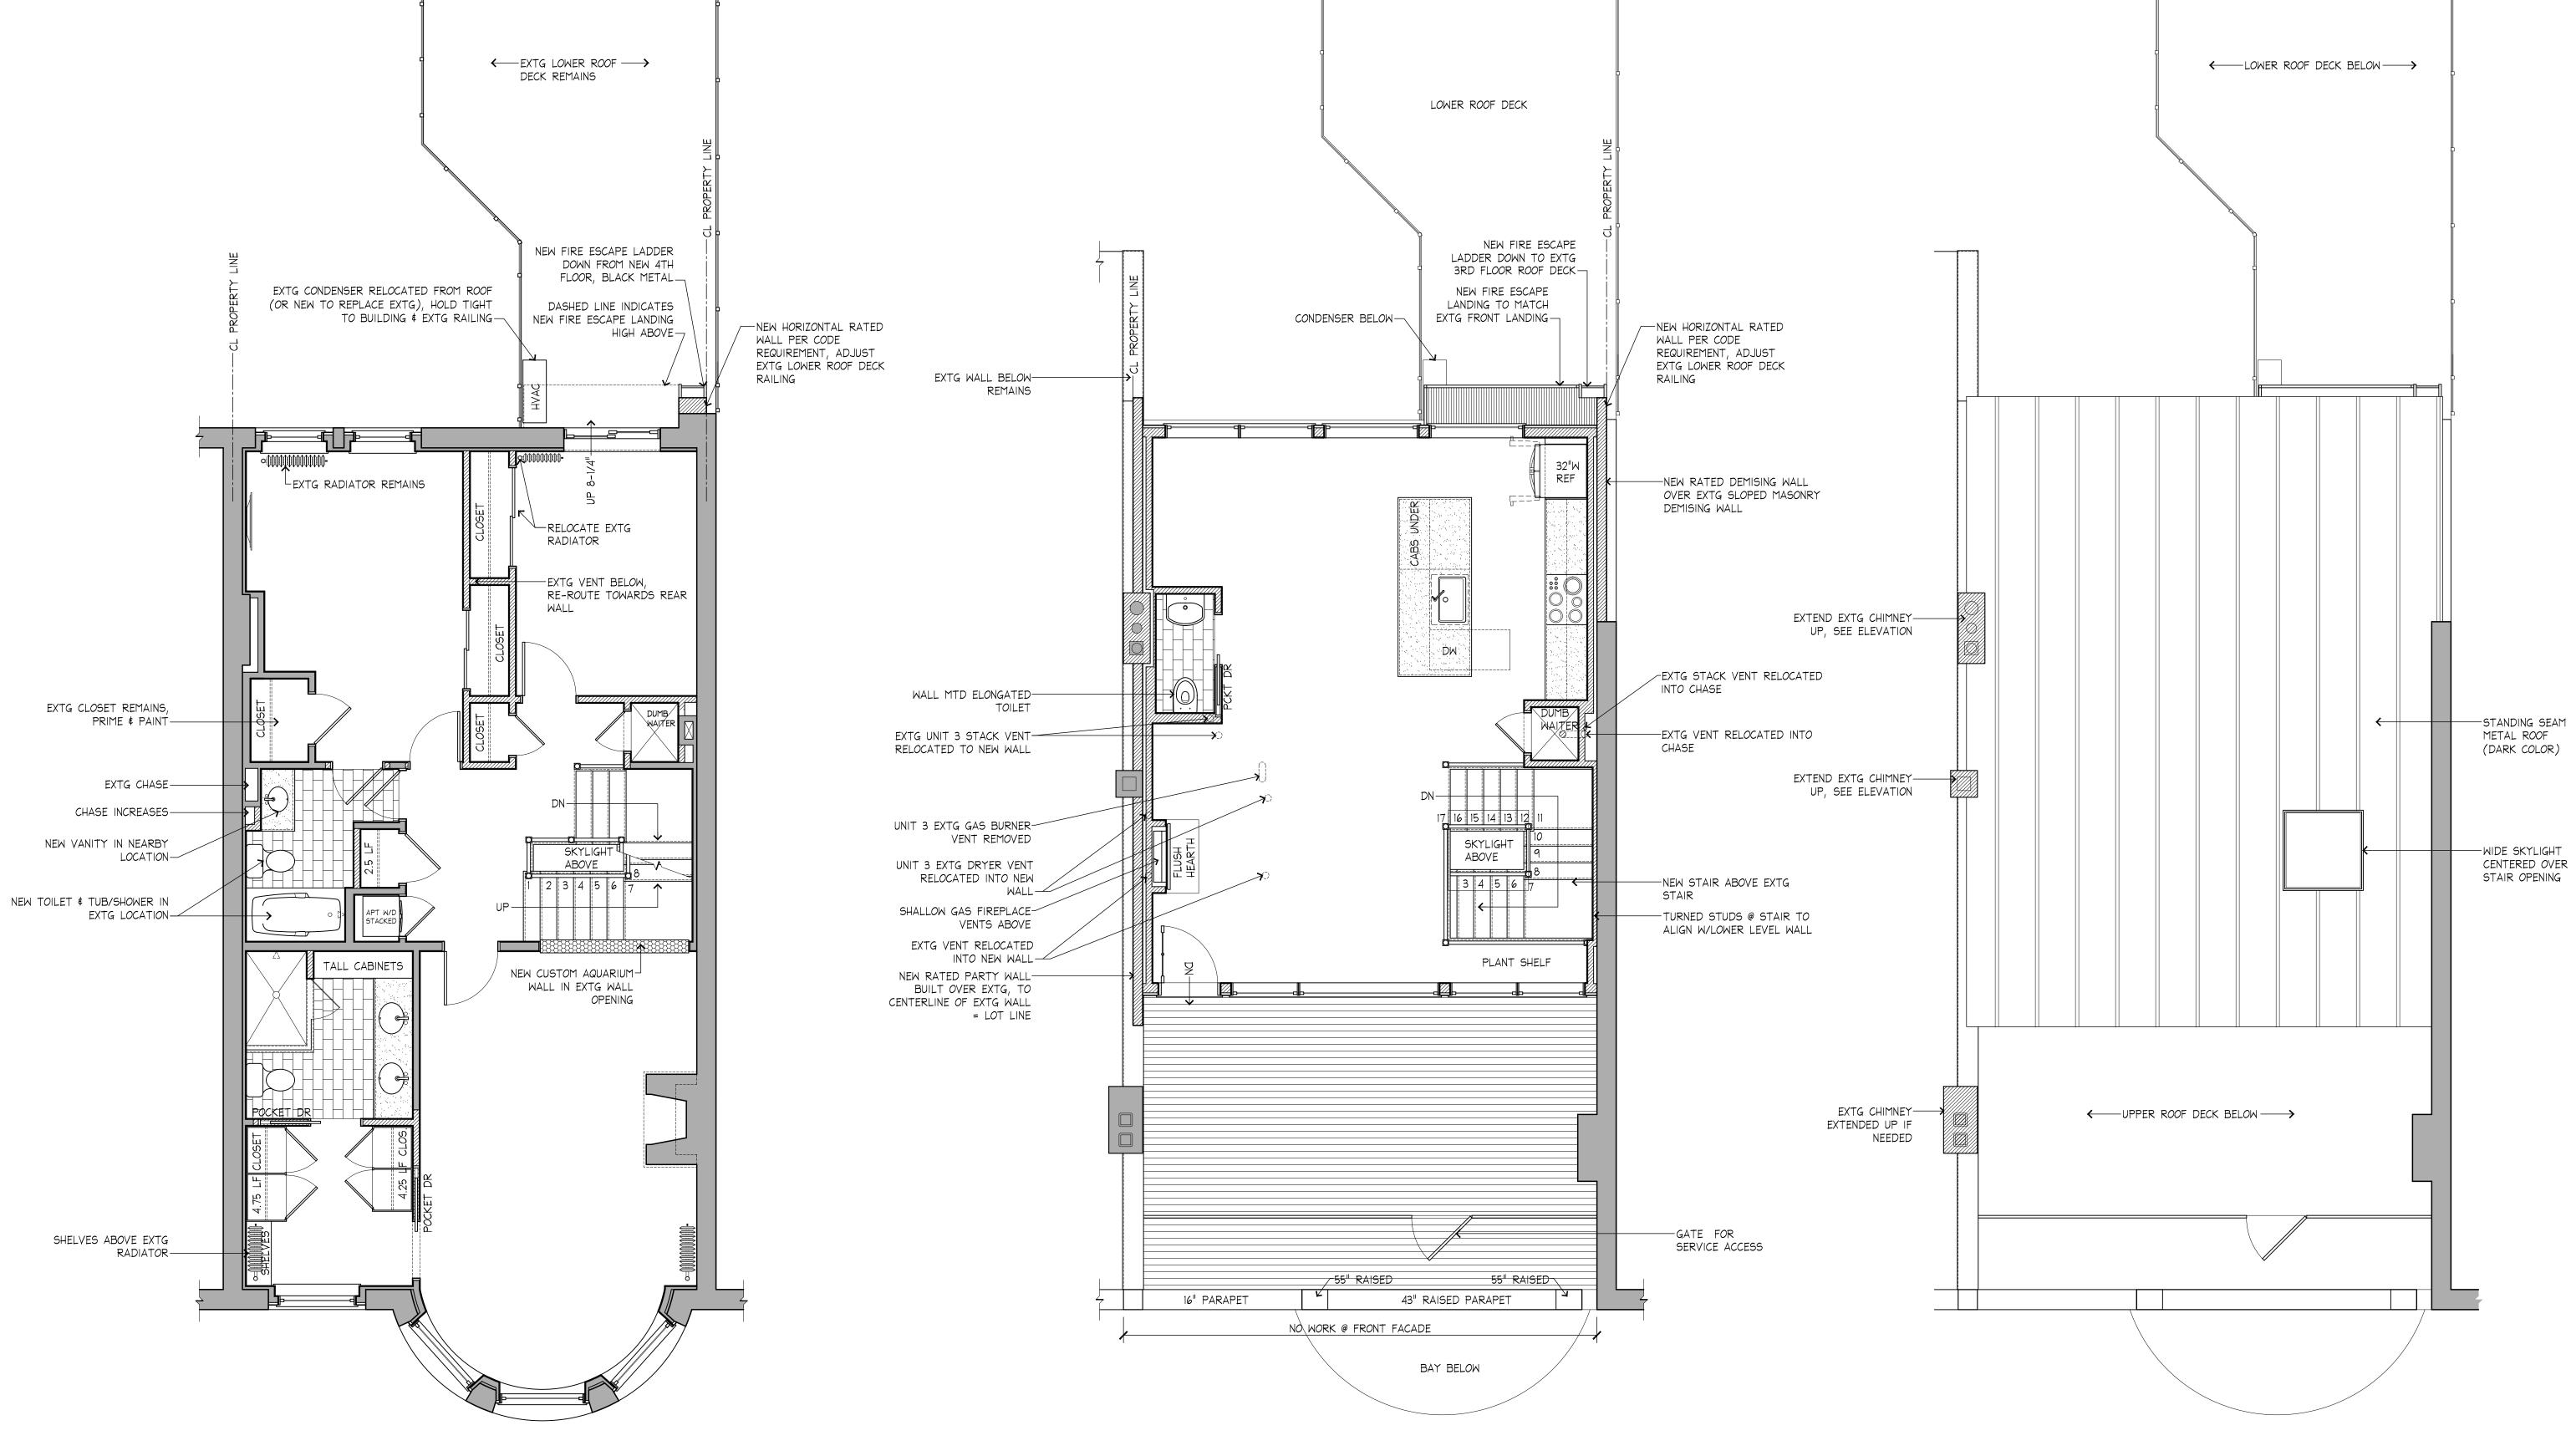


NEW FOURTH FLOOR:

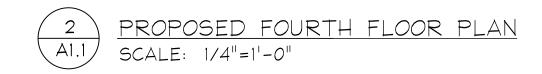




PROPOSED ST BOTOLPH ST. (NORTHWEST) ELEVATION SCALE: 1/4"=1'-0"

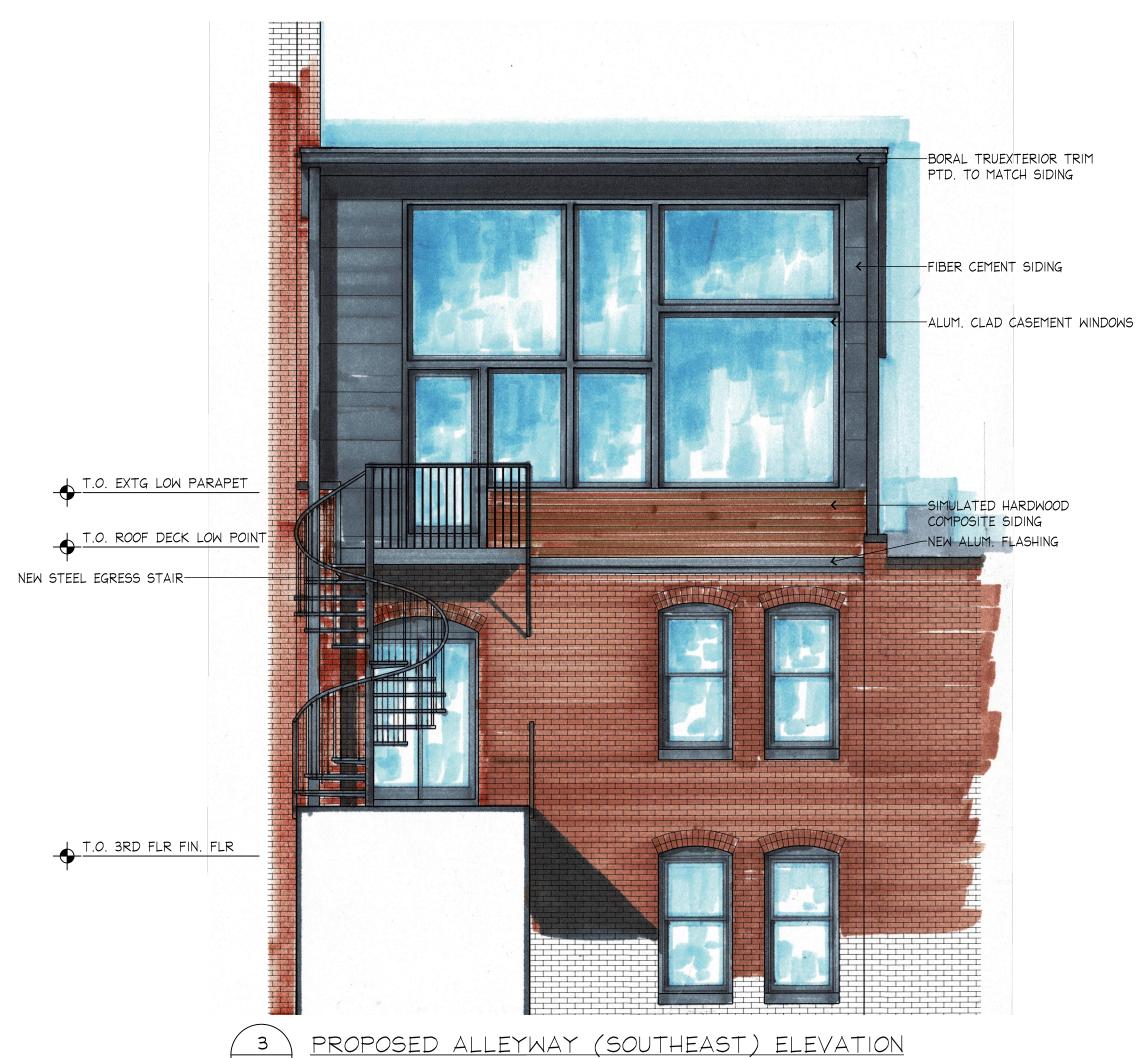

PROPOSED ALLEYWAY (SOUTHEAST) ELEVATION SCALE: 1/4"=1'-0"

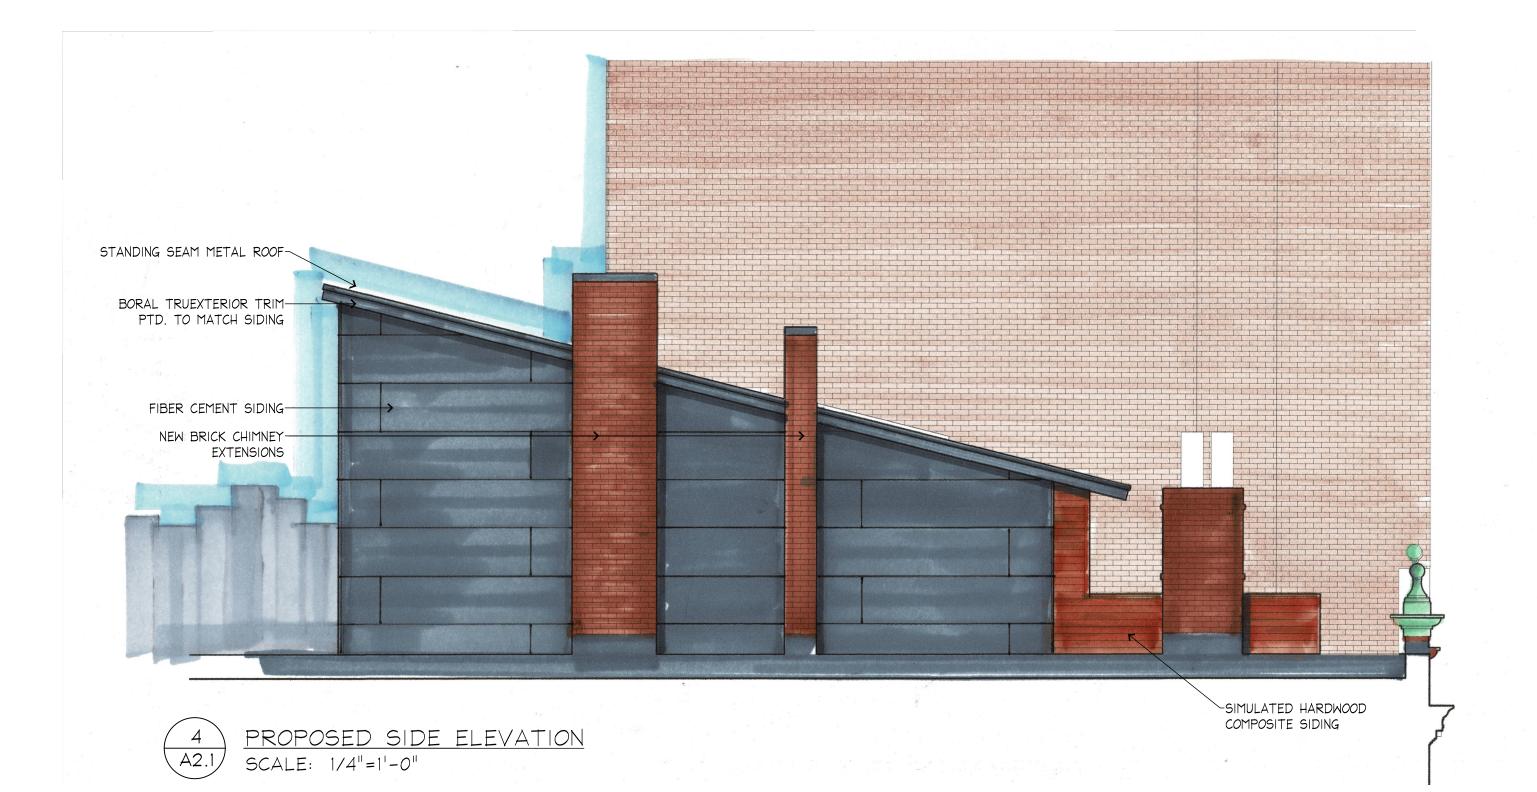

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ARTMENT STREET,

PR0P(

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A2.1

Sheet Number:

29 OLD SUGAR ROAD BOLTON MASSACHUSETTS 01740 p:978.79.7999 e:info@tuckandtuck.com WWW.TUCKANDTUCK.COM ← 2 BLACKWOOD STREET SIDE WALL BEYOND → 28'-2" ARTMENT STREET, 27'-3" ROUGH INTERIOR 10'-11/2" ROOF DEGK — PARTIAL VISIBILITY MAY BE APPROVED (NON-REFLECTIVE, BLACK METAL, THIN) T.O. EXTG LOW PARAPET T.O. ROOF DECK LOW POINT HIGH PARAPET — LNEW 16" FLOOR JOISTS SISTERED TO EXISTING ROOF JOISTS LOW PARAPET-T.O. 3RD FLR FIN. FLR T.O. 2ND FLR FIN. FLR T.O. IST FLR FIN. FLR 8'-0" SIDEWALK 8'-1" SIDEWALK 42'-0" ST. BOTOLPH STREET Sheet Number: T.O. BASEMENT SLAB 75'-4" A3.1 SECTION THRU NEW ADDITION: MONO PITCHED ROOF
SCALE: 1/4"=1'-0"