DocuSign Envelope ID: AA4B139A-E7DE-4758-8307-6FF93DFE8DD5

— APPROVED –

BOSTON REDEVELOPMENT AUTHORITY

Design Review

10/12/2022

Board of Appeal Signature





PROJECT TYPE: NEW SITE BUILD - ROOFTOP


SITE NAME: INDIA STREET

SITE NUMBER: BOS-M00006

SITE ADDRESS: 131 STATE ST,

BOSTON, MA 02109

SITE TYPE: ROOF TOP

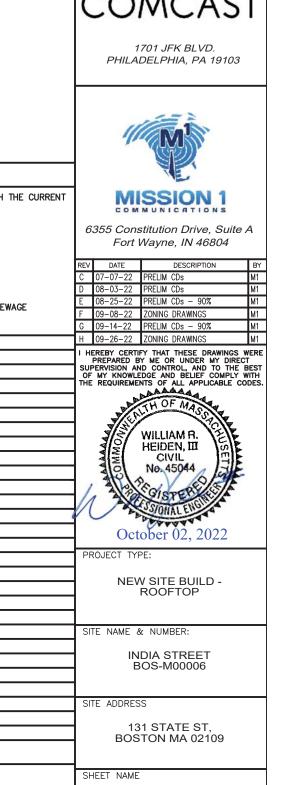

#### PROJECT INFORMATION APPLICABLE BUILDING CODES AND STANDARDS SCOPE OF WORK ALL WORK AND MATERIALS SHALL BE PERFORMED AND INSTALLED IN ACCORDANCE WITH THE CURRENT THE SCOPE OF WORK CONSISTS OF BUT IS NOT LIMITED TO: INDIA STREET SITE NAME: EDITIONS OF THE FOLLOWING CODES ADOPTED BY THE LOCAL GOVERNING AUTHORITIES. (3) NEW ALPHA WIRELESS AW3933-E-F ANTENNA SITE ADDRESS: 131 STATE ST. (3) NEW SAMSUNG RF4435D-71A RRU MASSACHUSETTS STATE BUILDING CODE STATE BOARD OF BOSTON, MA 02109 (3) NEW RFS JUNCTION BOXES BUILDING REGULATIONS & STANDARDS (1) NEW EQUIPMENT CABINET AND (1) OVP ROOFTOP SITE TYPE: ELECTRICAL CODE: MASSACHUSETTS STATE BUILDING CODE STATE BOARD OF (1) NEW 12 POSITION DISTRIBUTION PANEL BUILDING REGULATIONS & STANDARDS JURISDICTION: CITY OF BOSTON (3) NEW HYBRID CABLES AND (24) RF JUMPERS (2) NEW ANTENNA WALL MOUNTS AND (1) NEW UNISTRUT FRAME 0303823000 FACILITY IS UNMANNED AND NOT FOR HUMAN HABITATION ZONING CLASSIFICATION: ADA ACCESS REQUIREMENTS ARE NOT REQUIRED THIS FACILITY DOES NOT REQUIRE POTABLE WATER AND WILL NOT PRODUCE ANY SEWAGE OCCUPANCY TYPE: MULTIPLE USE PROPERTY / RES / COMMERCIAL USE CONSTRUCTION FEE DRAWING INDEX TITLE SHEET A-1 APPLICANT: ADDRESS: COMCAST CABLE COMMUNICATIONS MANAGEMENT C-1 OVERALL SITE PLAN ONE COMCAST CENTER, 1701 JOHN F. KENNEDY BLVD. PHILADELPHIA, PA 19103-2838 C-2 SITE PLAN - CONTRACTOR SHALL FURNISH ALL MATERIAL WITH THE EXCEPTION OF COMCAST SUPPLIED BUILDING ELEVATIONS C-3 CONTACT: DARREN SNODGRASS C-4 BUILDING ELEVATIONS - ALL MATERIAL SHALL BE INSTALLED BY THE CONTRACTOR, UNLESS STATED OTHERWISE PHONE: DARREN\_SNODGRASS@COMCAST.COM EMAIL: C-5 EQUIPMENT LAYOUT ANTENNA LAYOUTS AND EQUIPMENT SCHEDULE C-6 SITE COORDINATES: SITE LOCATION MAP C-7 ANTENNA ELEVATION DETAILS 42.358984 (1A) LATITUDE: LONGITUDE: -71.054235 (1A) ANTENNA ELEVATION DETAILS C-8 GROUND ELEV. (ASML): 11.0' AMSL (1A) EQUIPMENT DETAILS C-9 TISHMAN SPEYER ARCHSTONE PROPERTY OWNER: CONTACT: C-10 EQUIPMENT DETAILS JESSICA HUGHES PHONE: 212-715-0300 JHUGHES@TISHMANSPEYER.COM EMAIL: PROPERTY MANAGER: ROBERT ROBESKI CONTACT: 800-551-7483 EXT. 2245 RROBESKI@SBASITE.COM PHONE: FMAII: LANDLORD SITE NUMBER:

MISSION 1 COMMUNICATIONS 6355 CONSTITUTION DR, SUITE A FORT WAYNE, IN 46804

DARREN\_SNODGRASS@COMCAST.COM

DARREN SNODGRASS

(317) 979-1212

PHONE: (260) 436-3922

PROJECT MANAGER:

ADDRESS

CONTACT:

ENGINEER:

ADDRESS:

PHONE:

EMAIL:

DigSafe

PROJECT CONSULTANTS

COMCAST CABLE COMMUNICATIONS MANAGEMENT

ONE COMCAST CENTER, 1701 JOHN F. KENNEDY BLVD. PHILADELPHIA, PA 19103—2838

**DIRECTIONS** 

SCAN QR CODE FOR LINK TO SITE LOCATION MAP



RF ENGINEER

LANDLORD

APPROVALS


SITE ACQUISITION

TITLE SHEET

CONSTRUCTION MANAGER


SHEET NUMBER

T-1

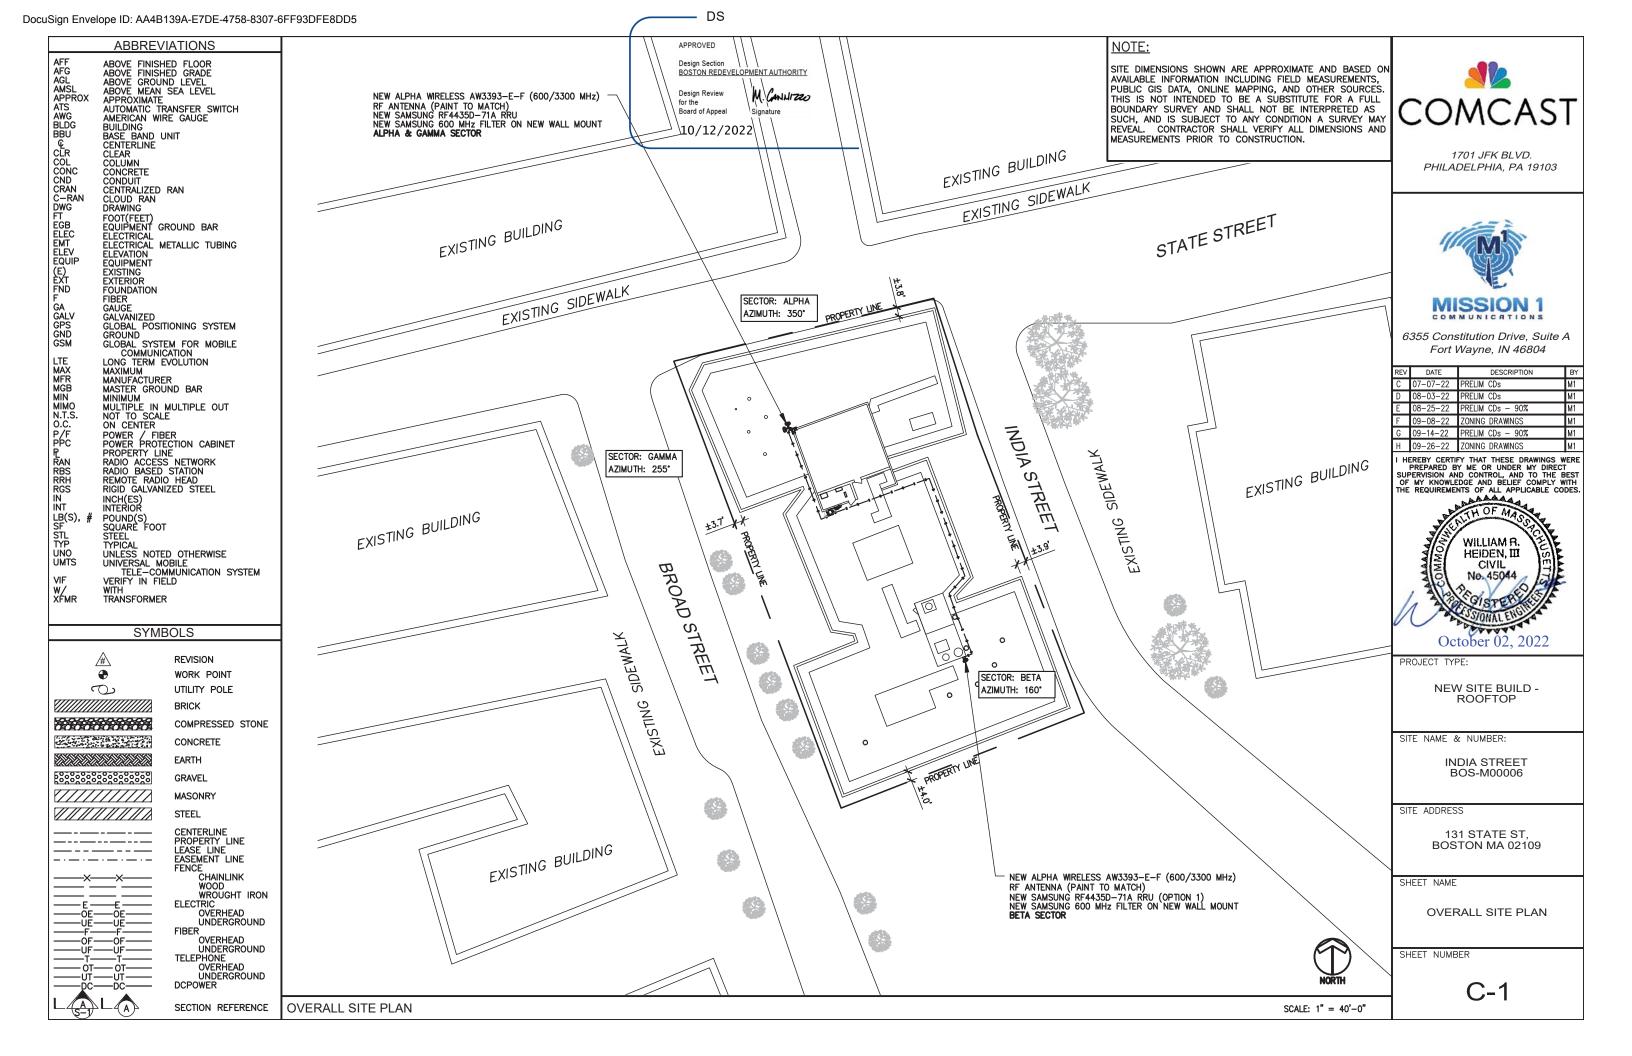

# NOTE:

SITE DIMENSIONS SHOWN ARE APPROXIMATE AND BASED ON AVAILABLE INFORMATION INCLUDING FIELD MEASUREMENTS, PUBLIC GIS DATA, ONLINE MAPPING, AND OTHER SOURCES. THIS IS NOT INTENDED TO BE A SUBSTITUTE FOR A FULL BOUNDARY SURVEY AND SHALL NOT BE INTERPRETED AS SUCH, AND IS SUBJECT TO ANY CONDITION A SURVEY MAY REVEAL. CONTRACTOR SHALL VERIFY ALL DIMENSIONS AND MEASUREMENTS PPIOP TO CONSTPUCTION

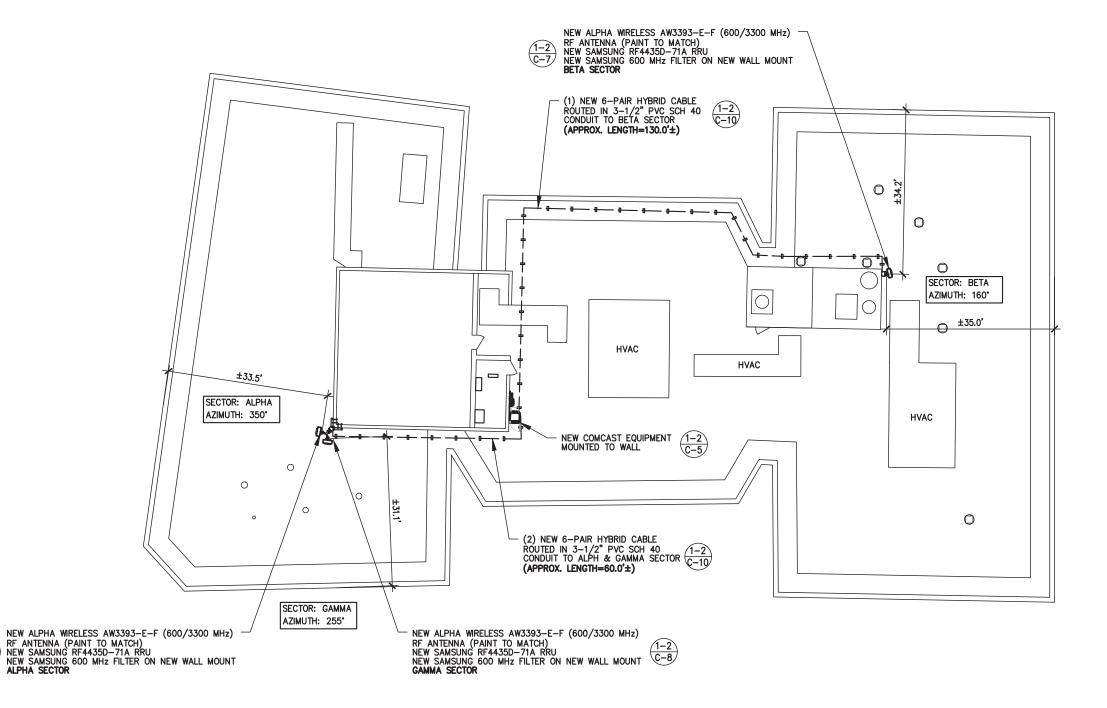




1701 JFK BLVD. PHILADELPHIA, PA 19103



6355 Constitution Drive, Suite A Fort Wayne, IN 46804

_			
REV	DATE	DESCRIPTION	BY
С	07-07-22	PRELIM CDs	М1
D	08-03-22	PRELIM CDs	М1
Ε	08-25-22	PRELIM CDs - 90%	М1
F	09-08-22	ZONING DRAWINGS	М1
G	09-14-22	PRELIM CDs - 90%	М1
Н	09-26-22	ZONING DRAWINGS	М1
п	09-20-22	ZUNING DRAWINGS	IVI

I HEREBY CERTIFY THAT THESE DRAWINGS WERE PREPARED BY ME OR UNDER MY DIRECT SUPERVISION AND CONTROL, AND TO THE BEST OF MY KNOWLEDGE AND BELIEF COMPLY WITH THE REQUIREMENTS OF ALL APPLICABLE CODES.

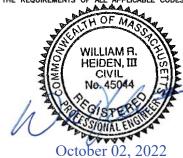

PROJECT TYPE:

NEW SITE BUILD -ROOFTOP

SITE NAME & NUMBER:

INDIA STREET BOS-M00006

SITE ADDRESS

131 STATE ST, BOSTON MA 02109

SHEET NAME

SITE PLAN

SHEET NUMBER

C-2



SITE PLAN

NOTES:

 CALCULATIONS FOR THE STRUCTURE AND ANTENNA MOUNTS HAVE BEEN PREPARED BY OTHERS.

2. CABLES NOT SHOWN FOR CLARITY.

CABLES TO BE ROUTED PER PASSING STRUCTURAL ANALYSIS. APPROVED

Design Section

BOSTON REDEVELOPMENT AUTHORITY

Design Review M. CANAITZEO

Board of Appeal 10/12/2022



1701 JFK BLVD. PHILADELPHIA, PA 19103



6355 Constitution Drive, Suite A Fort Wayne, IN 46804

REV	DATE	DESCRIPTION	Đ
С	07-07-22	PRELIM CDs	М
D	08-03-22	PRELIM CDs	М
Ε	08-25-22	PRELIM CDs - 90%	М
F	09-08-22	ZONING DRAWINGS	М
G	09-14-22	PRELIM CDs - 90%	М
Н	09-26-22	ZONING DRAWINGS	М

I HEREBY CERTIFY THAT THESE DRAWINGS WERE PREPARED BY ME OR UNDER MY DIRECT SUPERVISION AND CONTROL, AND TO THE BEST OF MY KNOWLEDGE AND BELIEF COMPLY WITH THE REQUIREMENTS OF ALL APPLICABLE CODES.



PROJECT TYPE:

NEW SITE BUILD -ROOFTOP

SITE NAME & NUMBER:

INDIA STREET BOS-M00006

SITE ADDRESS


131 STATE ST, BOSTON MA 02109

SHEET NAME

**BUILDING ELEVATIONS** 

SHEET NUMBER

C-3

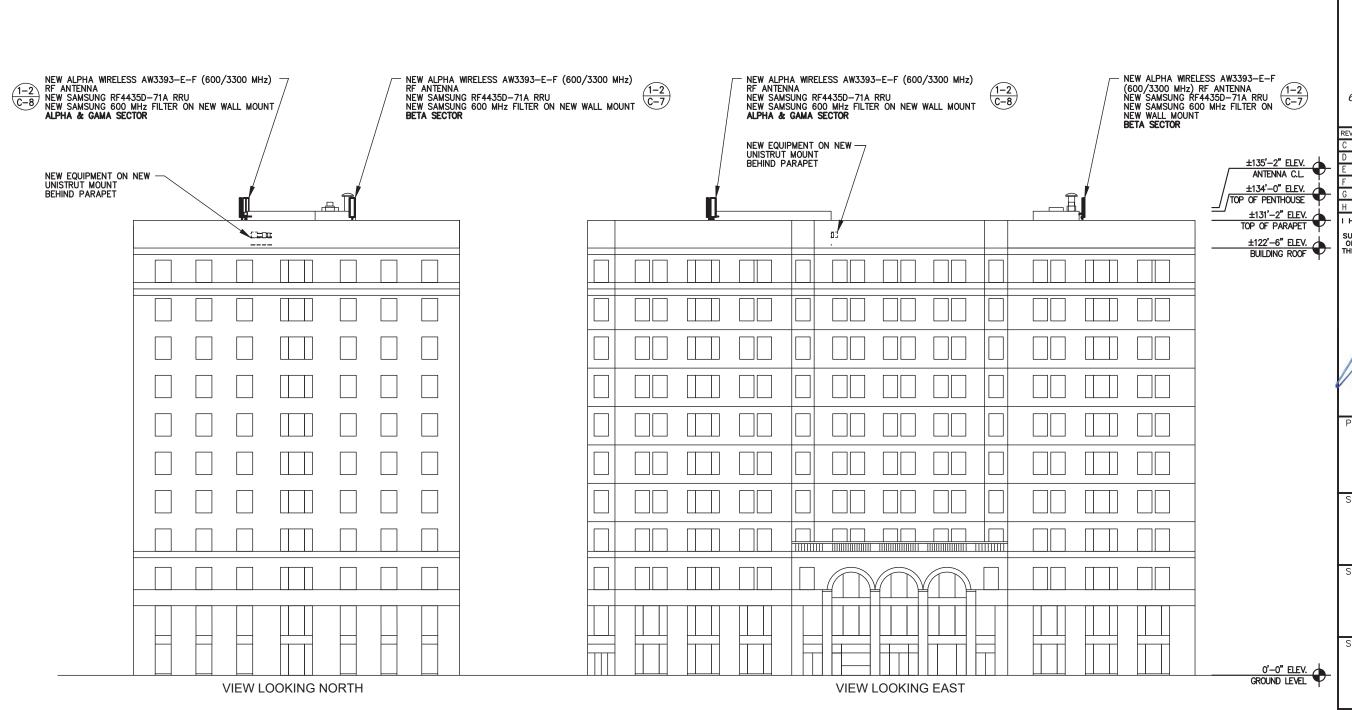

3. CABLES TO BE ROUTED PER PASSING STRUCTURAL

2. CABLES NOT SHOWN FOR CLARITY.

ANALYSIS.

APPROVED

BOSTON REDEVELOPMENT AUTHORITY

Design Review

M. CANHITZEO

10/12/2022

Board of Appeal



1701 JFK BLVD. PHILADELPHIA, PA 19103



6355 Constitution Drive, Suite A Fort Wayne, IN 46804

REV	DATE	DESCRIPTION	В
С	07-07-22	PRELIM CDs	М
D	08-03-22	PRELIM CDs	М
Ε	08-25-22	PRELIM CDs - 90%	M
F	09-08-22	ZONING DRAWINGS	M
G	09-14-22	PRELIM CDs - 90%	M
Н	09-26-22	ZONING DRAWINGS	M

I HEREBY CERTIFY THAT THESE DRAWINGS WERE PREPARED BY ME OR UNDER MY DIRECT SUPERVISION AND CONTROL, AND TO THE BEST OF MY KNOWLEDGE AND BELIEF COMPLY WITH THE REQUIREMENTS OF ALL APPLICABLE CODES.



PROJECT TYPE:

NEW SITE BUILD -ROOFTOP

SITE NAME & NUMBER:

INDIA STREET BOS-M00006

SITE ADDRESS


131 STATE ST, **BOSTON MA 02109** 

SHEET NAME

**BUILDING ELEVATIONS** 


SHEET NUMBER

C-4

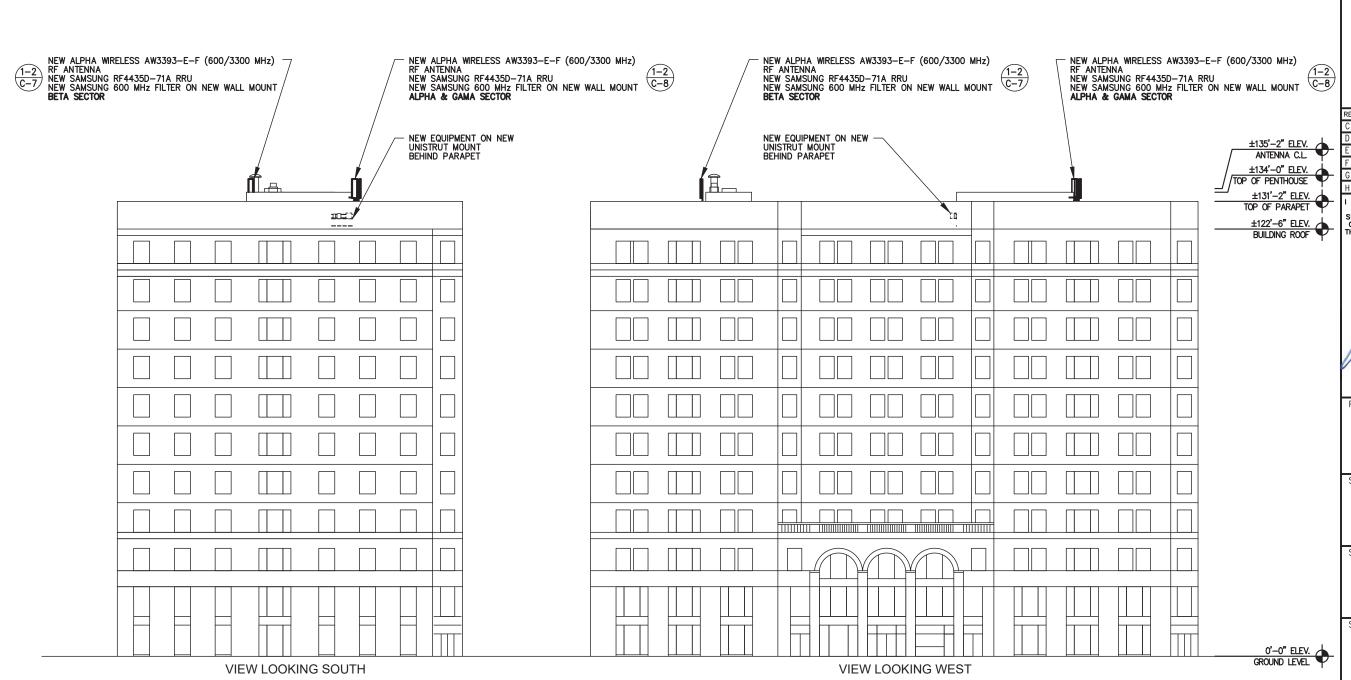

BUILDING ELEVATIONS (SOUTH FACE & WEST FACE)

SCALE: 1" = 30'-0"

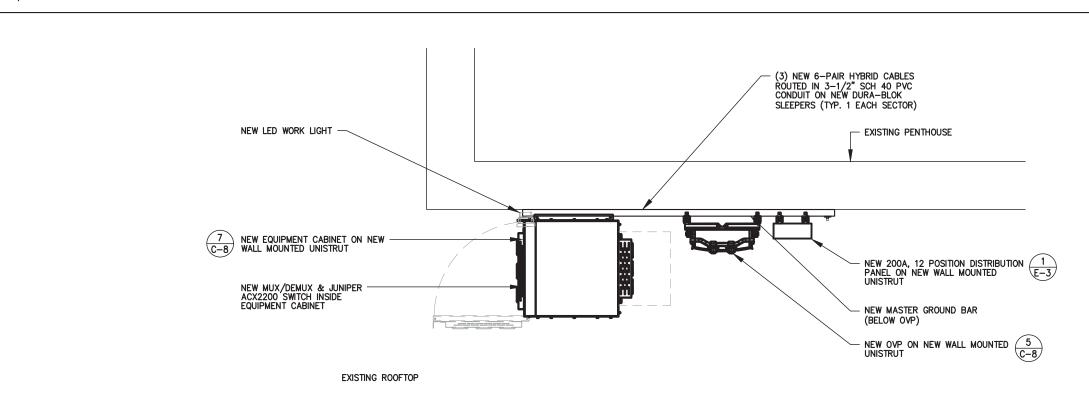

COMCAST


1701 JFK BLVD. PHILADELPHIA, PA 19103



6355 Constitution Drive, Suite A Fort Wayne, IN 46804

REV	DATE	DESCRIPTION	BY
С	07-07-22	PRELIM CDs	M1
D	08-03-22	PRELIM CDs	M1
Ε	08-25-22	PRELIM CDs - 90%	M1
F	09-08-22	ZONING DRAWINGS	М1
G	09-14-22	PRELIM CDs - 90%	М1
Н	09-26-22	ZONING DRAWINGS	М1

I HEREBY CERTIFY THAT THESE DRAWINGS WERE PREPARED BY ME OR UNDER MY DIRECT SUPERVISION AND CONTROL, AND TO THE BEST OF MY KNOWLEDGE AND BELIEF COMPLY WITH THE REQUIREMENTS OF ALL APPLICABLE CODES.

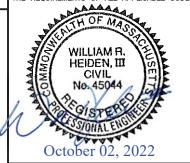

PROJECT TYPE:

NEW SITE BUILD -ROOFTOP

SITE NAME & NUMBER:

INDIA STREET BOS-M00006

SITE ADDRESS

131 STATE ST, BOSTON MA 02109

SHEET NAME


**EQUIPMENT LAYOUT** 

SHEET NUMBER

C-5

EQUIPMENT LAYOUT

SCALE: 1/2" = 1'-0"

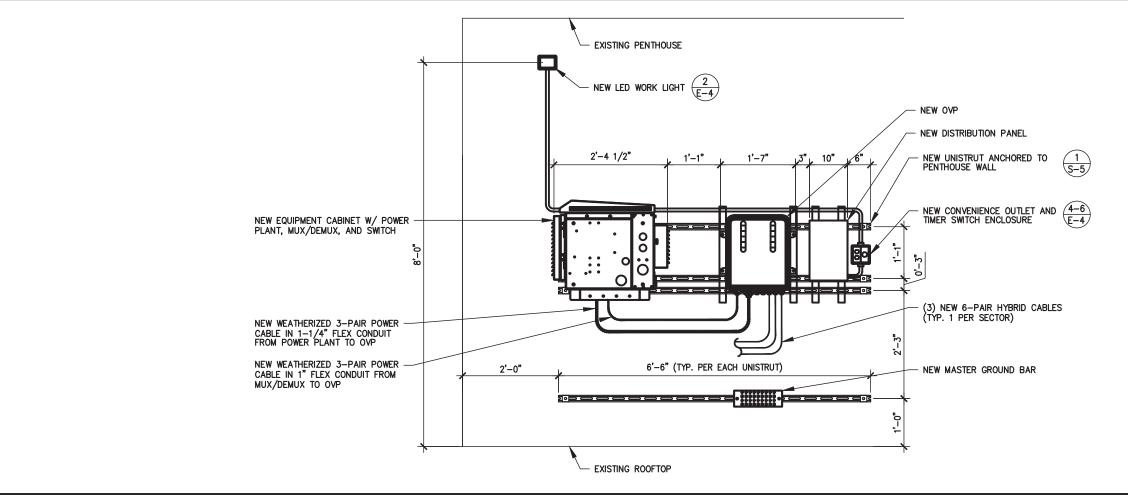

SCALE: 1/2" = 1'-0" 2

**EQUIPMENT ELEVATION LAYOUT** 

	ANTENNA AND CABLE SCHEDULE												
SECTOR	POSITION	ANTENNA MFR	ANTENNA MODEL NUMBER	AZIMUTH (DEG)	RAD CENTER (FT)	MECH. TILT	ELEC. TILT	RRU/RADIO MFR	RRU/RADIO MODEL	TRUNK CABLE SIZE & QTY	JUMPER CABLE SIZE & QTY	CABLE LENGTH +10% (FT)	
ALPHA	1	ALPHA WIRELESS	AW3393-E-F	350	135.1'	0	10	SAMSUNG	RF4435D-71A	(1) NEW 3-PAIR CONDUCTOR 6-PAIR FIBER HYBRID CABLE	(1) NEW 1-PAIR POWER JUMPERS (1) NEW 2-PAIR FIBER JUMPERS (8) NEW 1/2" RF JUMPER	60' HYBRID CABLE	(
ВЕТА	1	ALPHA WIRELESS	AW3393-E-F	160	135.1'	0	12	SAMSUNG	RF4435D-71A	(1) NEW 3-PAIR CONDUCTOR 6-PAIR FIBER HYBRID CABLE	(1) NEW 1-PAIR POWER JUMPERS (1) NEW 2-PAIR FIBER JUMPERS (8) NEW 1/2" RF JUMPER	130' HYBRID CABLE	
GAMMA	1	ALPHA WIRELESS	AW3393-E-F	255	135.1'	0	12	SAMSUNG	RF4435D-71A	(1) NEW 3-PAIR CONDUCTOR 6-PAIR FIBER HYBRID CABLE	(1) NEW 1-PAIR POWER JUMPERS (1) NEW 2-PAIR FIBER JUMPERS (8) NEW 1/2" RF JUMPER	60' HYBRID CABLE	r




1701 JFK BLVD. PHILADELPHIA, PA 19103



6355 Constitution Drive, Suite A Fort Wayne, IN 46804

REV	DATE	DESCRIPTION	BY
С	07-07-22	PRELIM CDs	M1
D	08-03-22	PRELIM CDs	M1
Ε	08-25-22	PRELIM CDs - 90%	М1
F	09-08-22	ZONING DRAWINGS	M1
G	09-14-22	PRELIM CDs - 90%	M1
Н	09-26-22	ZONING DRAWINGS	М1

I HEREBY CERTIFY THAT THESE DRAWINGS WERE PREPARED BY ME OR UNDER MY DIRECT SUPERVISION AND CONTROL, AND TO THE BEST OF MY KNOWLEDGE AND BELIEF COMPLY WITH THE REQUIREMENTS OF ALL APPLICABLE CODES.

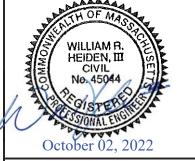

PROJECT TYPE:

NEW SITE BUILD -ROOFTOP

SITE NAME & NUMBER:

INDIA STREET BOS-M00006

SITE ADDRESS


131 STATE ST, BOSTON MA 02109

SHEET NAME

ANTENNA LAYOUT AND EQUIPMENT SCHEDULE

SHEET NUMBER


C-6

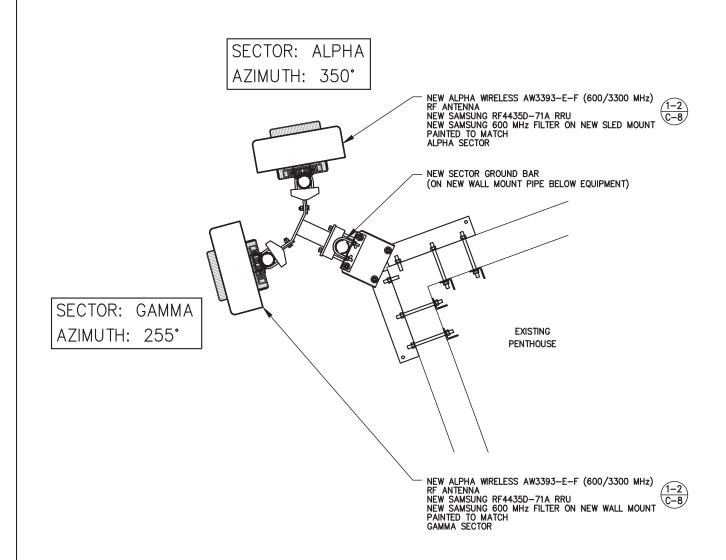



- NEW ALPHA WIRELESS AW3393-E-F (600/3300 MHz) RF ANTENNA NEW SAMSUNG RF4435D-71A RRU NEW SAMSUNG 600 MHZ FILTER NEW SECTOR GROUND BAR ON NEW WALL MOUNT BETA SECTOR

SECTOR: BETA AZIMUTH: 160°

ANTENNA LAYOUT

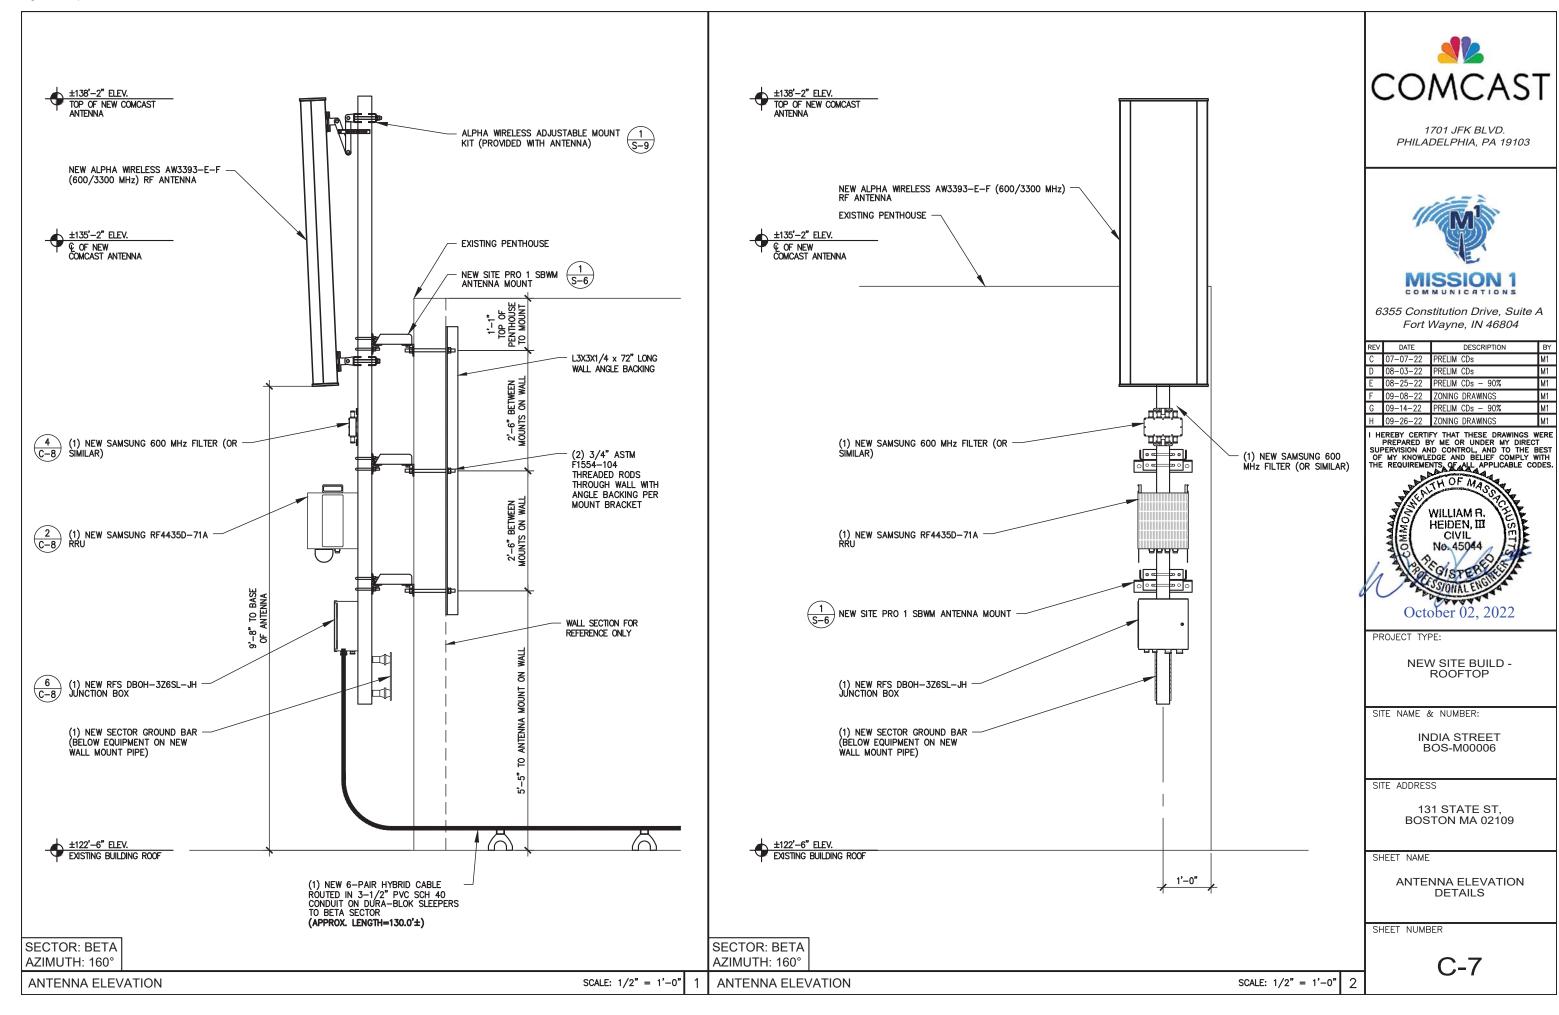

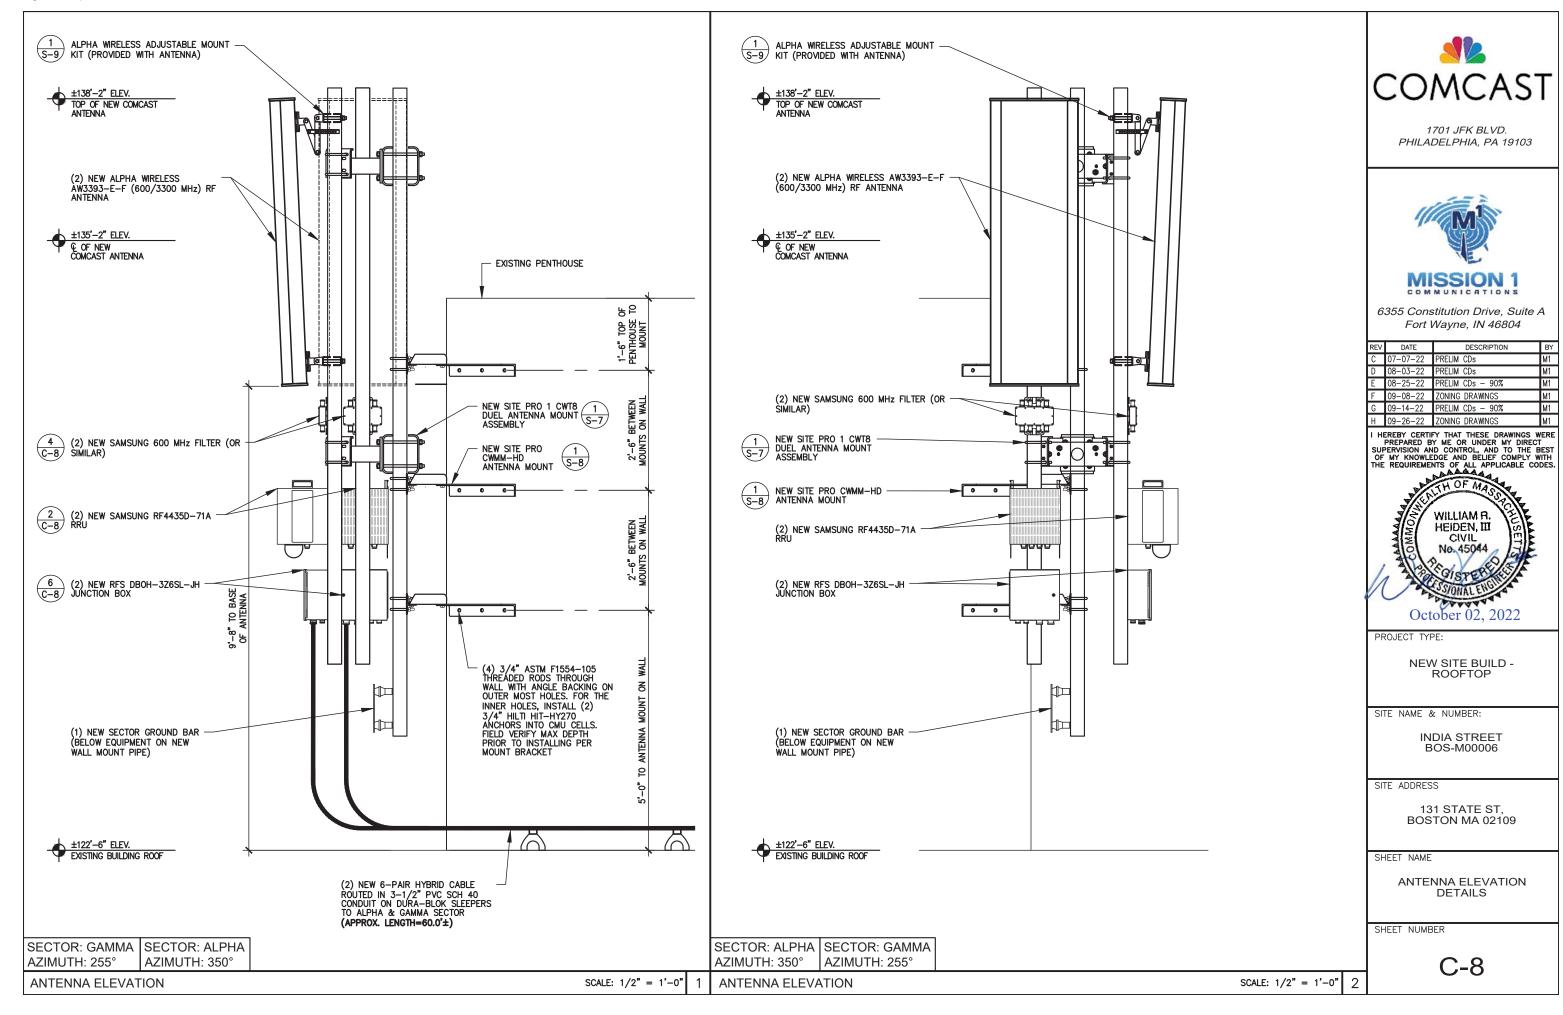

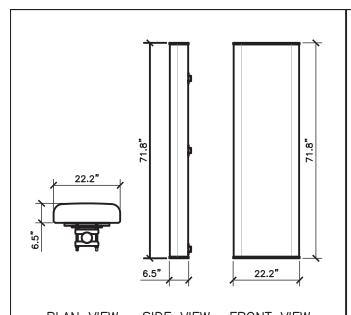

SIDE VIEW FRONT VIEW PLAN VIEW

ALPHA WIRELESS - AW3933-E-F (OR SIMILAR)

OUTDOOR DIRECTIONAL MULTI-BAND ANTENNA

FREQUENCY RANGES ANTENNA


BRACKET TOTAL WEIGHT

ANTENNA DETAIL

617-698 MHz 3300-4000 MHz 60.5 Lbs 11.5 Lbs 72.0 Lbs

SCALE: N.T.S.

TARRID PROTECTO

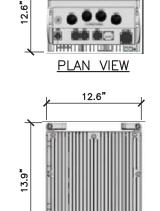

12.6"

FRONT VIEW

SAMSUNG - RF4435D-71A (OR SIMILAR)

600/700 MHz 4T4R RRU

WEIGHT

RADIO DETAIL

FREQUENCY RANGE n 71 DL: 617-652 MHz


n 71 UL: 663-698 MHz B 85 DL: 728-746 MHz B 85 UL: 698-715 MHz

74.96 Lbs

SCALE: N.T.S.

9.5" 

PLAN VIEW

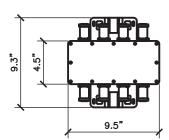

FRONT VIEW

SAMSUNG - FT-4C-2021001 (OR SIMILAR) 600 MHz FILTÉR

Notes:

FREQUENCY RANGE

617-698 MHz

Passive cooling door shown.

Proposal to Comcast is to

use a door-mounted TEC,

CMC8 only supports three 50A rectifiers from a

which expands thermal

capacity to 400W.


thermal perspective

WEIGHT

FILTER DETAIL

6.61 Lbs

SCALE: N.T.S.

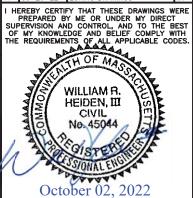

COMCAST

1701 JFK BLVD.

PHILADELPHIA, PA 19103

MISSION 1

6355 Constitution Drive, Suite A

Fort Wayne, IN 46804

DESCRIPTION

М1

М1

М1

М1

M1

М1

DATE

07-07-22 PRELIM CDs

08-03-22 PRELIM CDs

08-25-22 | PRELIM CDs - 90%

09-14-22 PRELIM CDs - 90%

09-08-22 ZONING DRAWINGS

09-26-22 ZONING DRAWINGS

PROJECT TYPE:

NEW SITE BUILD -ROOFTOP

SITE NAME & NUMBER:

INDIA STREET BOS-M00006

SITE ADDRESS

131 STATE ST, **BOSTON MA 02109** 

SHEET NAME

**EQUIPMENT DETAILS** 

SHEET NUMBER

C-9

(OR SIMILAR)


DIMENSIONS (HxWxD) TOTAL WEIGHT

RFS - DBOH-3Z6SL-JH JUNCTION BOX

13.6"x12.4"x5.9" 15.0 Lbs CMC-S8 Equipment Cabinet

**NOT USED** 

### Model 58B0-P1-A00D00-00

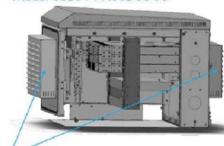

Louver feature with filter on both front and rear doors

# Standard features include on alarm block, a

Cabinet Features

high-temp thermostat, cabiner accessibility (ED light, and a full height rear access panel

3

- Cooling: Passive Cooling\*
- Pad, pole, Hérane and wall mounting options Cabinet supports most power OEM equipment such as AC power panels and rectifier shelves

## Dimensions and Weight

Size: 24" W x 22" D x 22" H

SCALE: N.T.S.

- Rack space: BRU of 19" rack mounting space
- Telcordia GR-487 Compliant OSHA Approved Safety Agency Listed Safety Agency Listed

\* Hardened equipment to -40° C to +65° C

# Field Replacement Units (FRUs) and Accessories

Orderable Code#	
760242246	H-Frame/Wall Mount Kit, CMC
760242249	Pole Mount, CMC
760244679	CMC-S8 Plinth, 5" High
760242239	FRU, Solar Shield, CMC, Small Format

RAYCAP - RKEDC-3969-PF-48 (OR SIMILAR) DC SURGE PROTECTION

DIMENSIONS (HxWxD) TOTAL WEIGHT

20.17"x18.9"x7.22"

SCALE: N.T.S. 5 JUNCTION BOX DETAIL SCALE: N.T.S. 6 EQUIPMENT CABINET DETAIL SCALE: N.T.S. **OVP DETAIL** 

