
PROPOSED ADDITION & RENOVATION

21 WELLINGTON STREET BOSTON, MA 02118

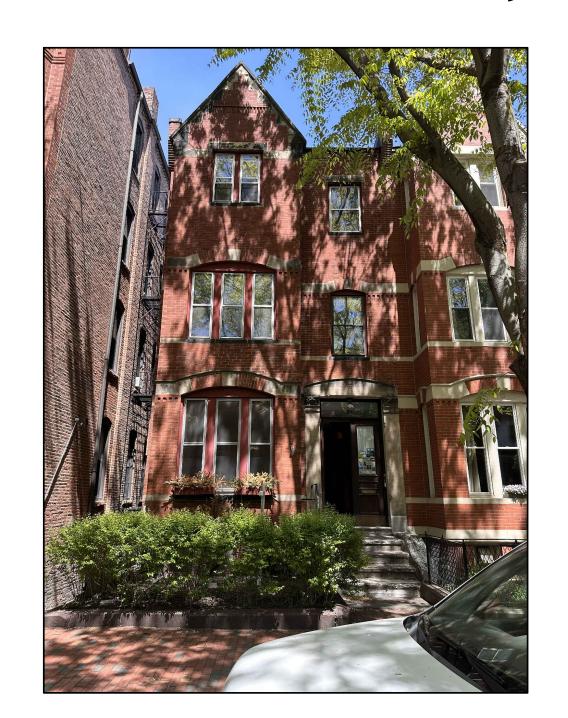



ZONING SUMMARY Use Regulations: Section Table Proposed 2F **Dimensional Regulations**: Table **Row House** Condition Row House NONE Min Required Lot Width and EX'G 3,002 SF PROP Max FAR 2.00 3 STORIES / 34.0' | 3 STORIES / 34.0 Usable Open 200 SF / UNIT NO CHANGE NONE, 7.0' NO CHANGE Min Rear Yard Overlays: EX'G PARK'G - 2 SPACES RESTRICTED PARKING REQ'D PARK'G - .7 SPACE/DU Other Non-Dimensional Zoning Issues: **CODE SUMMARY EX'G TYPE 3B CONSTRUCTION** PROPOSED R-3 USE GROUP (TWO-FAMILY) ZONE: MFR, SOUTH END Revision Date SOIL TESTING Project No: 2024100 Scale: NTS Date: 06-21-2024 **KEY** Drawn By: DF Drawing Name SMOKE DETECTOR

COVER

SHEET

Sheet No.

HEAT DETECTOR

DOOR TYPE


WINDOW TYPE

NEW WALL

1 HOUR WALL (SEE C.T. 1/A-3.1)

CARBON MONOXIDE DETECTOR

1 HOUR CLG. ABOVE (SEE C.T.1F/A-3.1)

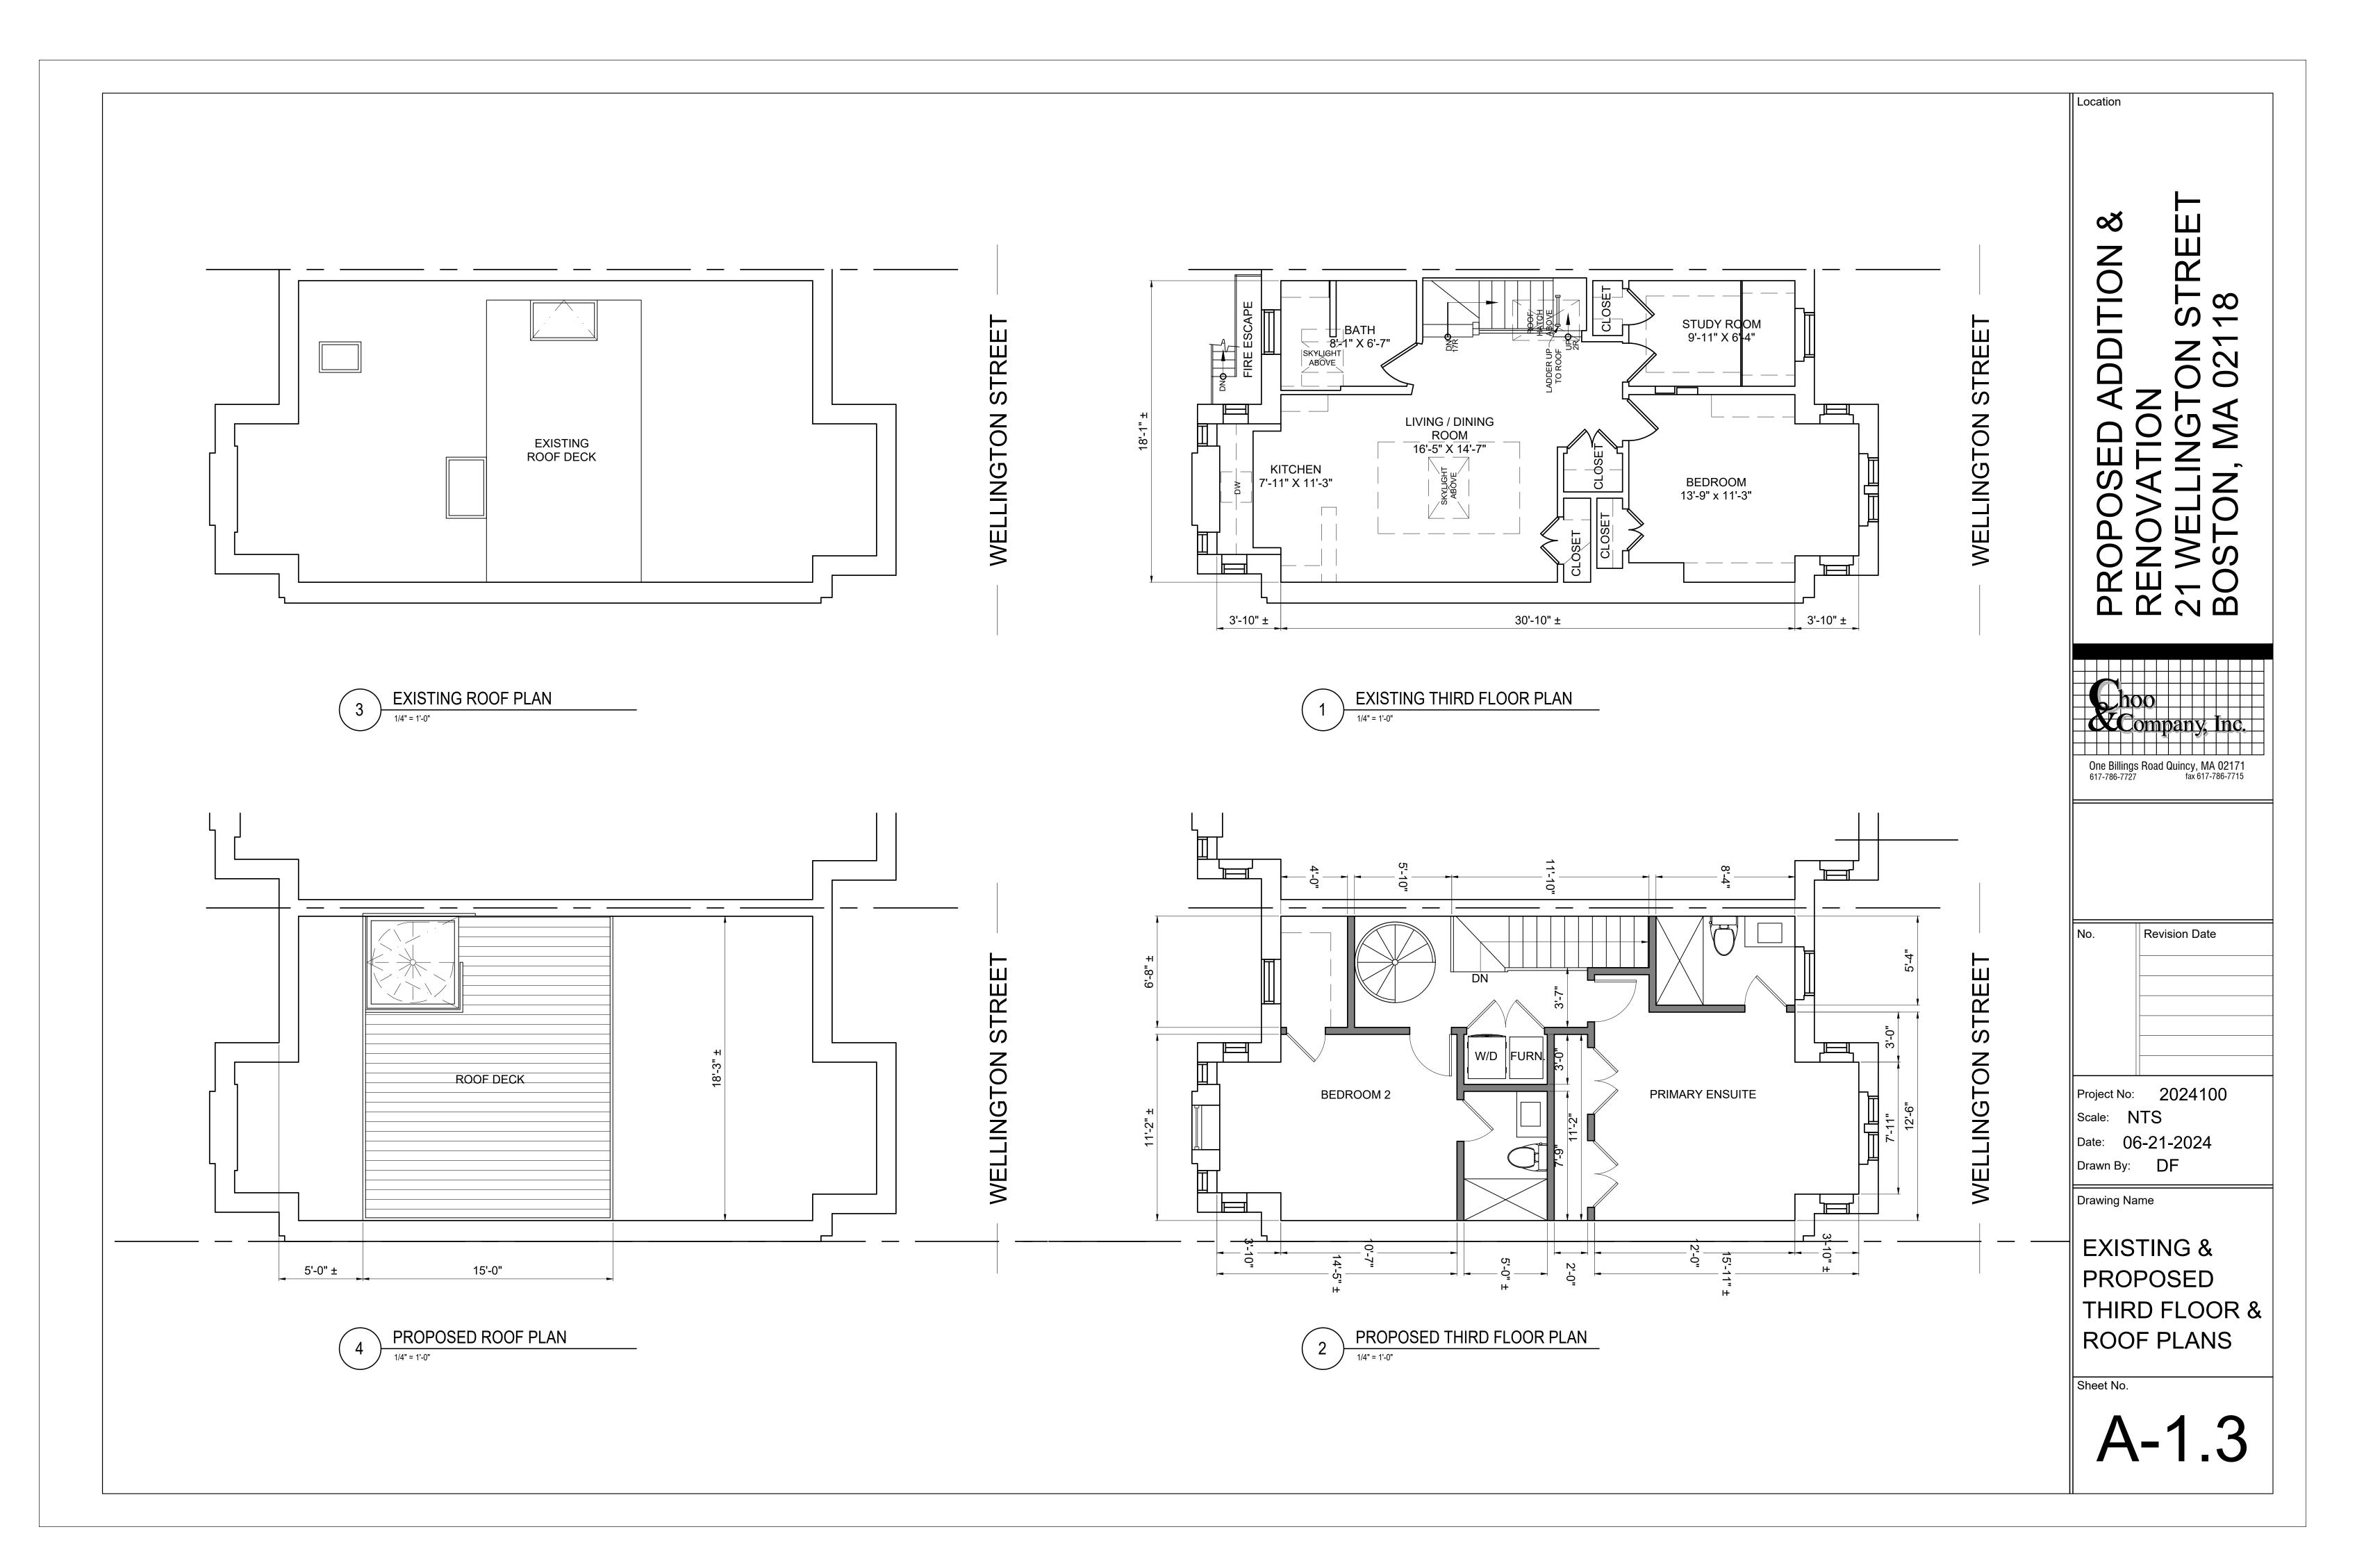





1 EXISTING REAR ELEVATION

1/4" = 1'-0"



OPOSED ADDITION & NOVATION
WELLINGTON STREET



No.	Revision Date

Project No: 2024100

Scale: NTS
Date: 06-21-2024

Drawn By: DF

Drawing Name

GENERAL NOTES

CLEAN MASONRY W/ PROSOCO
 GENTLE DETERGENT

REPOINT MASONRY AS REQ'D W/
 1 PART CEMENT
 2 PARTS LIME
 7-9 PARTS SAND
 PAINT MASONRY STEPS,


CURBING & BANDS W/
BENJAMIN MOORE ABINGTON


PUTTY, HC-99


EXISTING &
PROPOSED
REAR
ELEVATIONS

Sheet No.

A-2.2

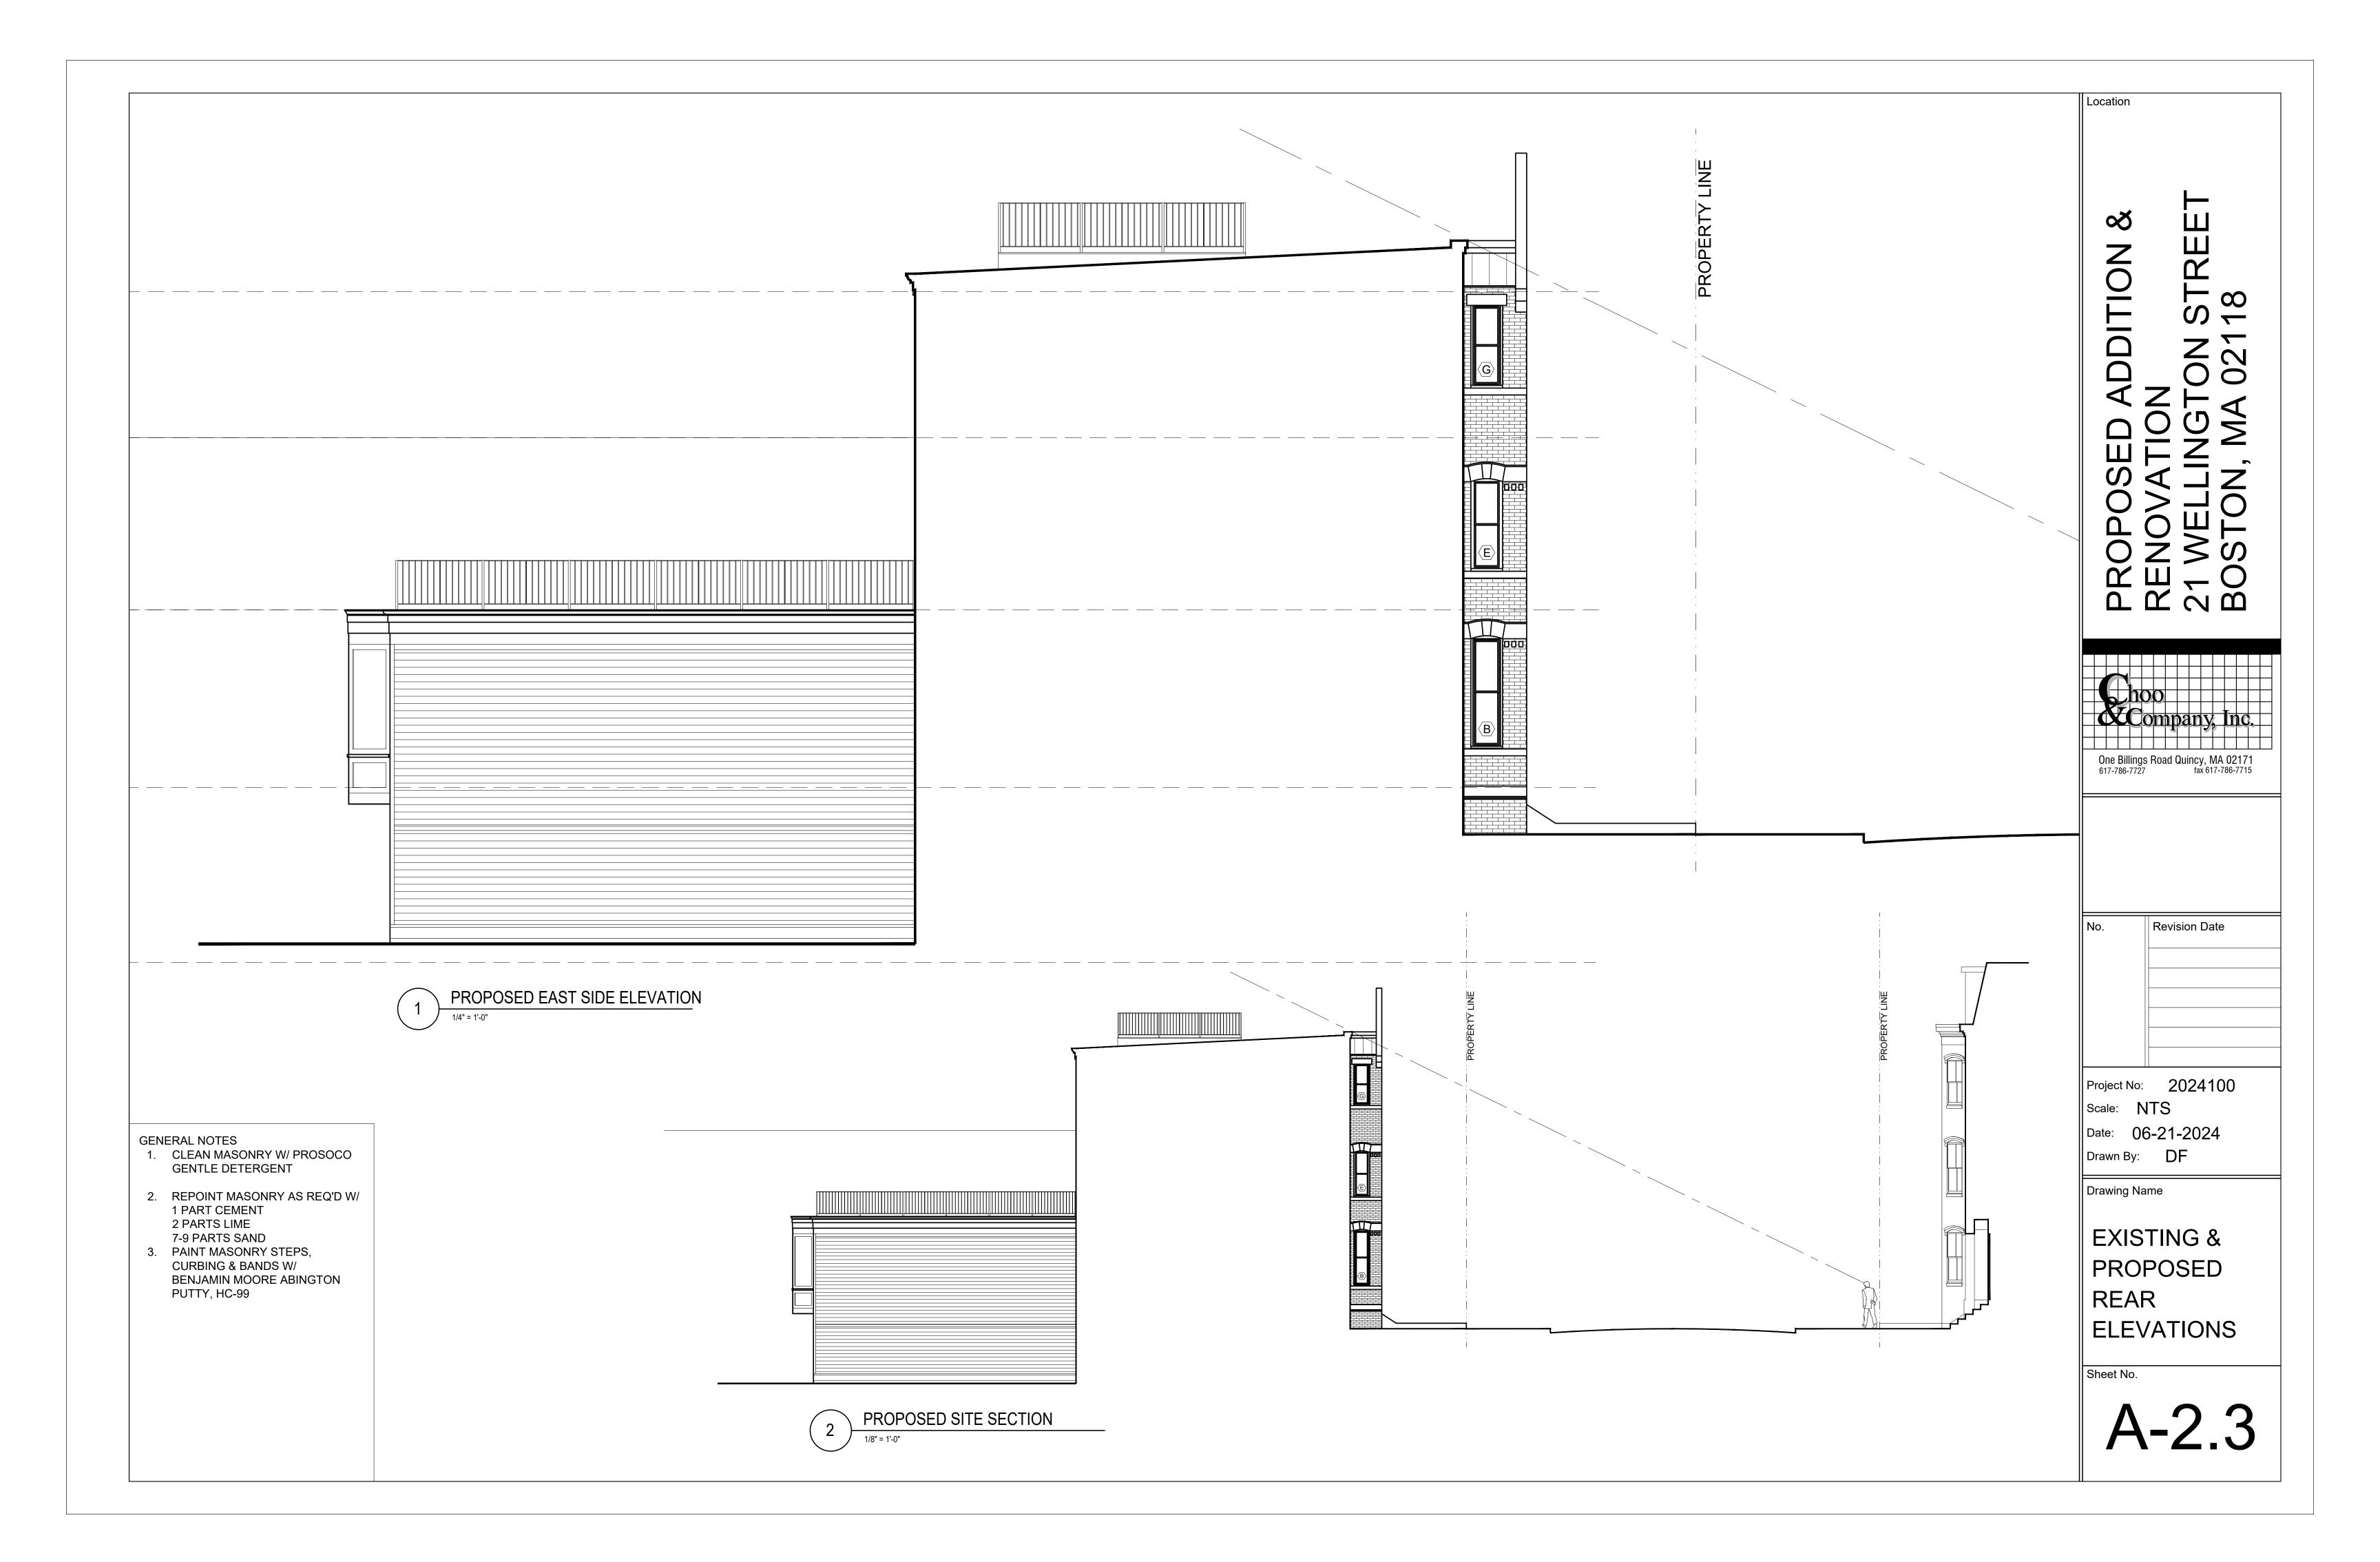


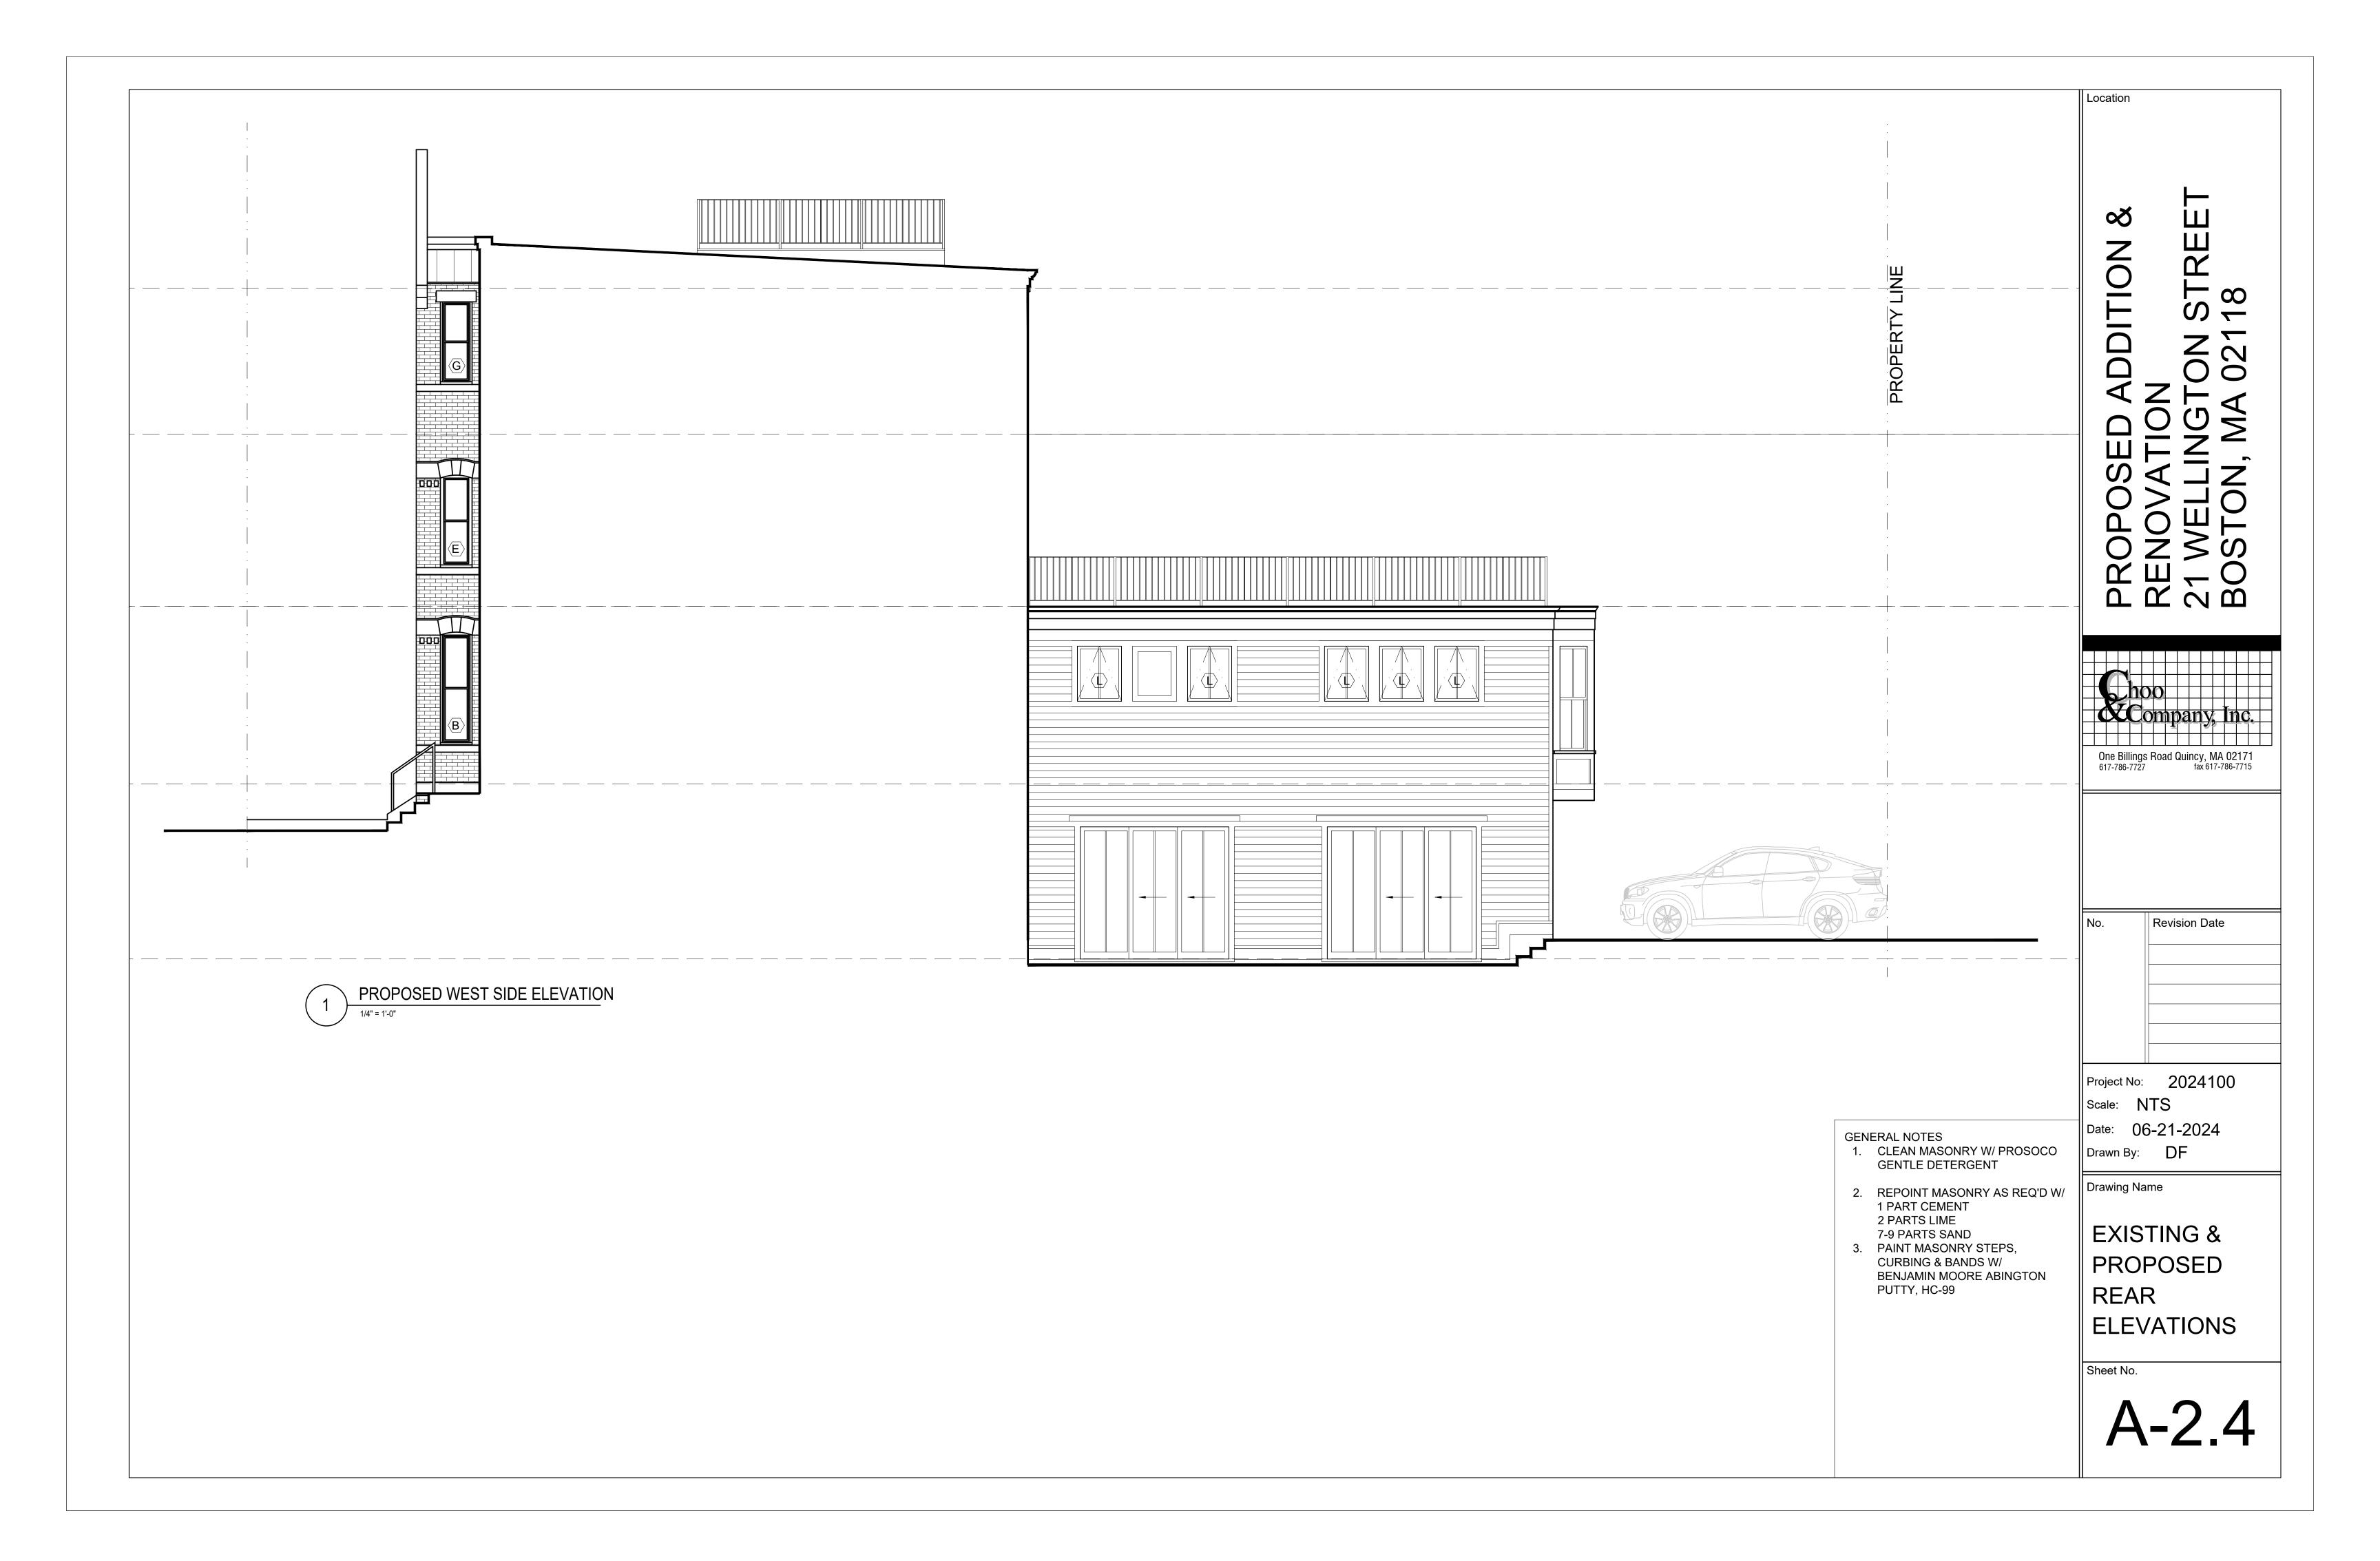


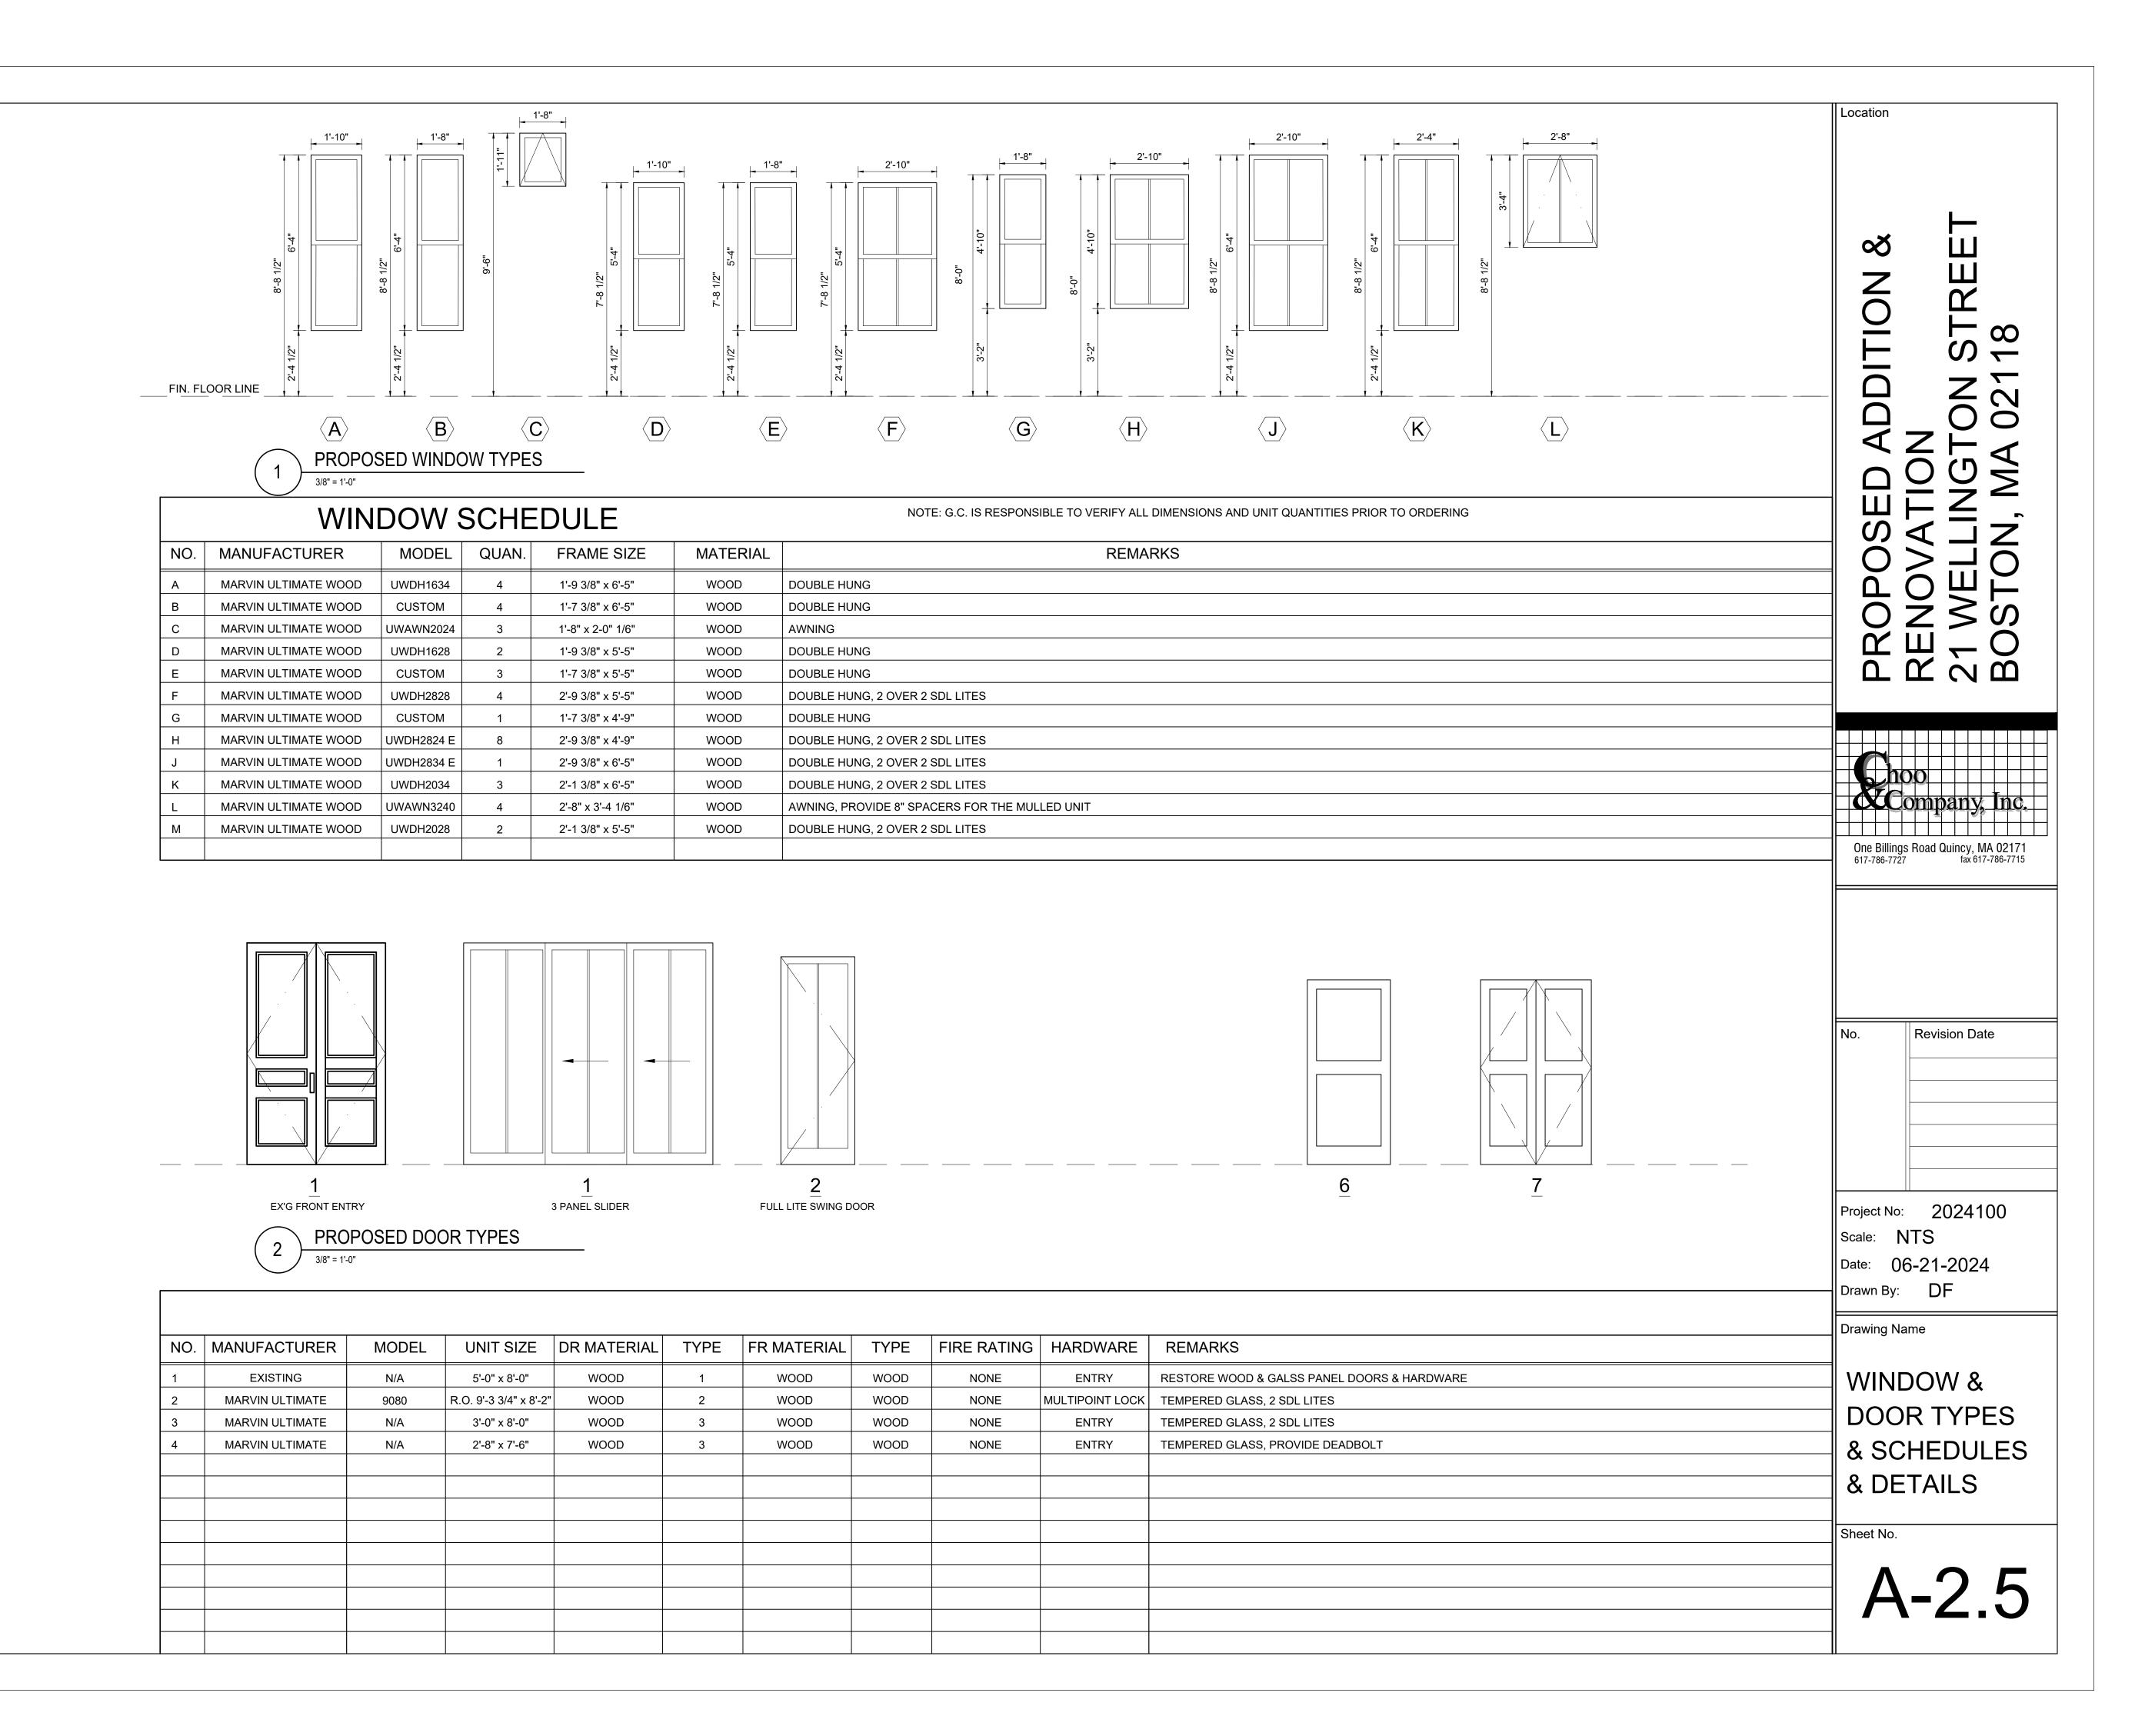



Standard Insulating Glass Divided Lite Options

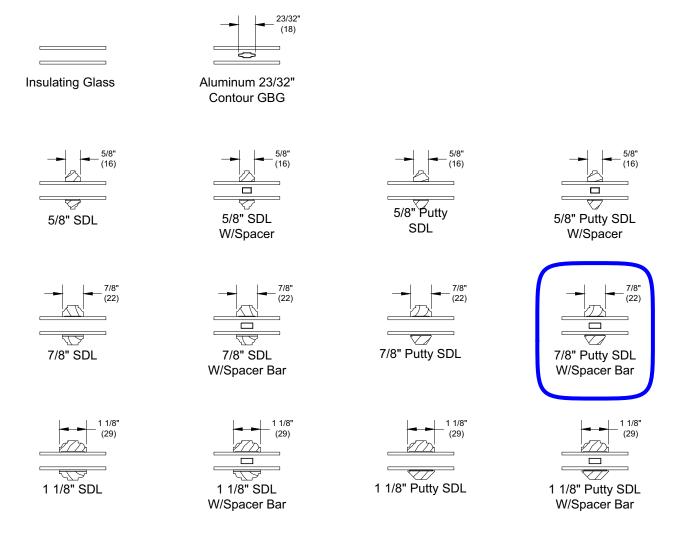

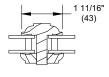

1 11/16" IG ADL


NOTE: Due to the inherent qualities of tempered glass, daylight gaps may be seen when using simulated divided lite bars. Daylight gaps could be visible between the internal spacer bar and surface applied bars when viewing from an acute angle to the glass on the following applications:

- Tempered glass over 72" high while using 5/8" SDL bars
- Tempered glass over 91" high while using 7/8" SDL bars.




Section Details: Operating


Scale: 3" = 1' 0"

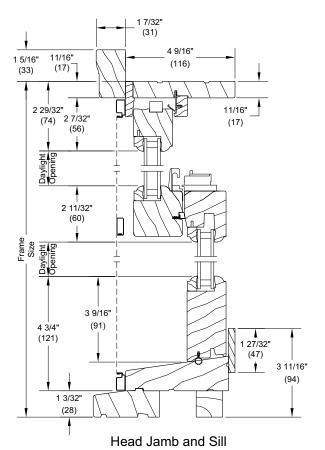


Double Hung

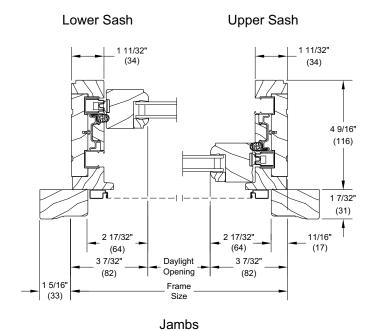


Single Hung

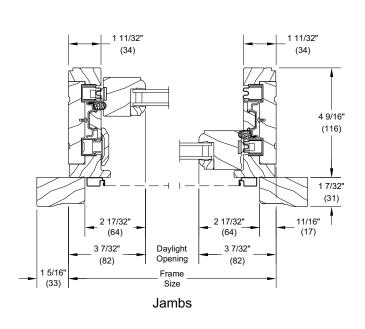


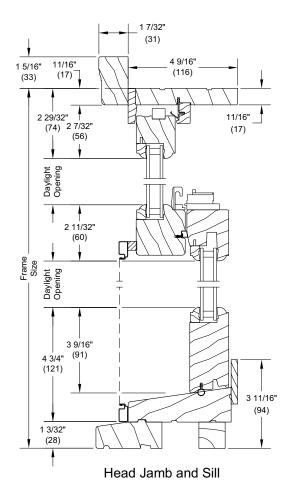



Egress and Vent Opening Measurements for Full Frame Casement and Awning

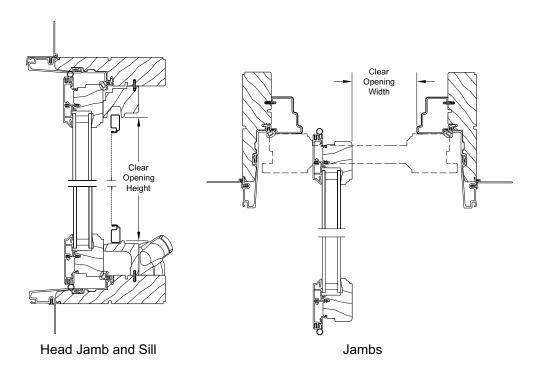


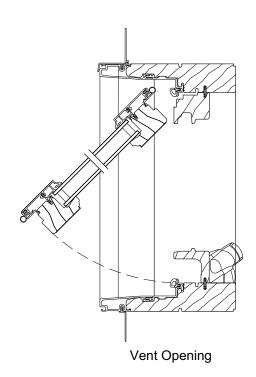




Inswing Section Details: Operating

Scale: 3" = 1' 0"

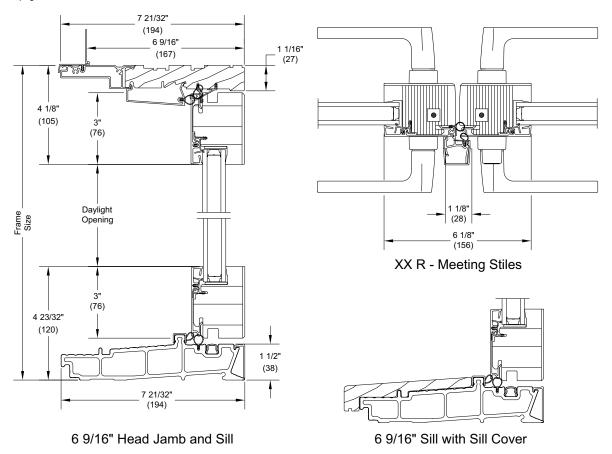

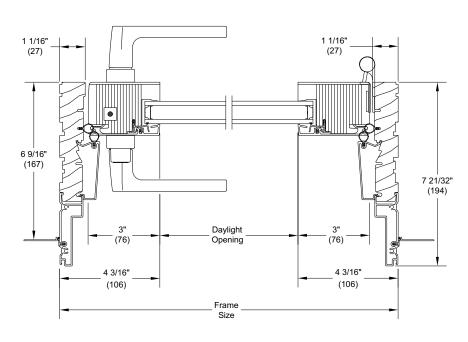


6 9/16" X R Jamb



Section Details: Operating (1 3/4" Panels, Standard: Ogee, Interior Glazing Profile)

Scale: 3" = 1' 0"

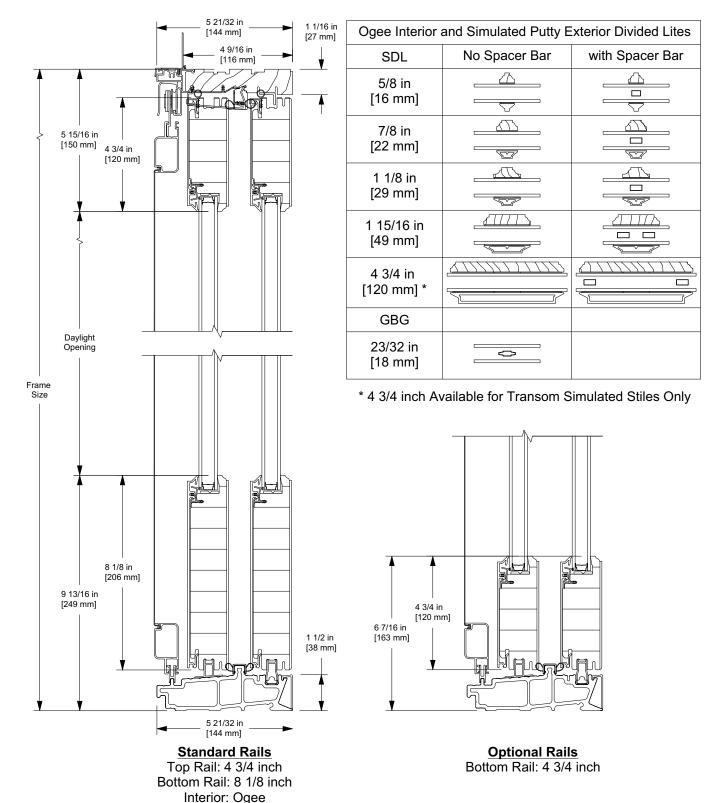

NOTE: Due to the inherent qualities of tempered glass, daylight gaps may be seen when using simulated divided lite bars. Daylight gaps could be visible between the internal spacer bar and surface applied bars when viewing from an acute angle to the glass on the following applications:


- Tempered glass over 72" high while using 5/8" SDL bars
- Tempered glass over 91" high while using 7/8" SDL bars.

Exterior: Simulated Putty



Section Details: Operating (1 3/4" Panels, Horizontal)

Scale: 3" = 1' 0"

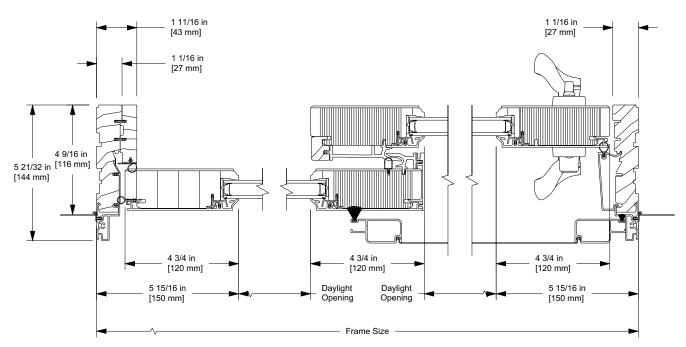


OX 4 9/16 inch Jambs



Section Details: Stationary (1 3/4" Panels)

Scale: 3" = 1' 0"

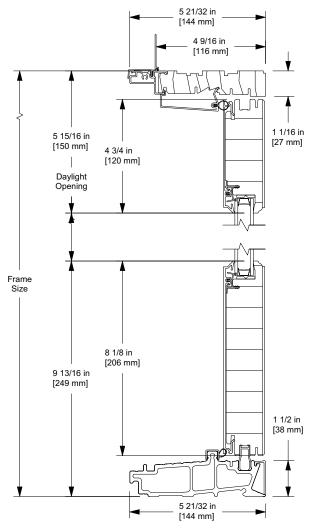

O 4 9/16 inch Head and Sill

